PROJECT:


### PROPOSED ANIMAL KEEPING

CLIENT:

L.HOWLETT

ADDRESS:

### 2312 STEVE IRWIN WAY, LANDSBOROUGH

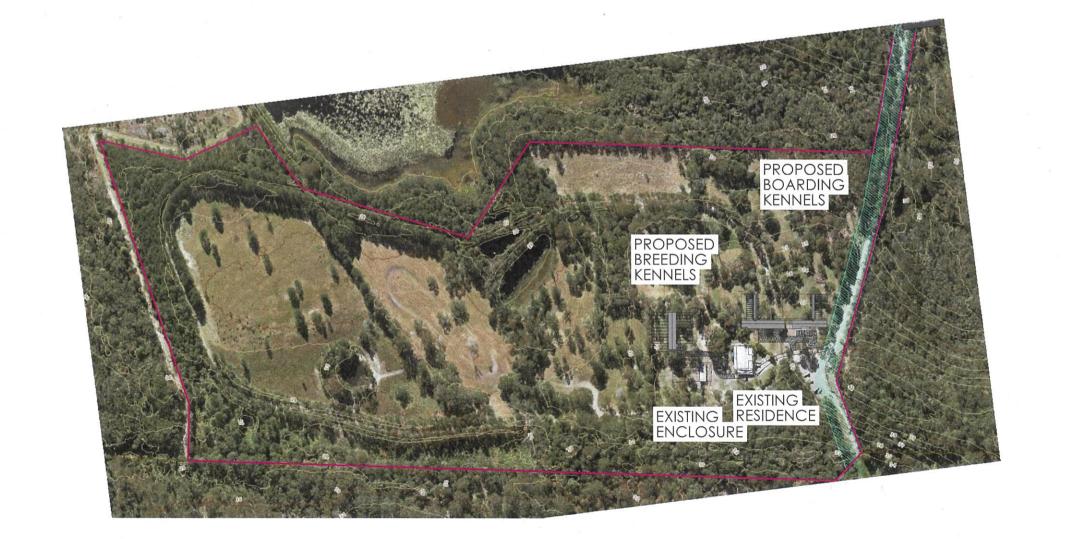




180606-SK5 ADMIN/OFFICE FLOOR PLAN 180606-SK6 BOARDING KENNELS/ADMIN/OFFICE ELEVS

180606-SK7


BREEDING KENNELS PLAN

180606-SK8 BREEDING KENNELS ELEVATIONS


180606-SK9 EXISTING RESIDENCE

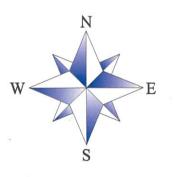


ISSUED FOR PLANNING APPROVAL

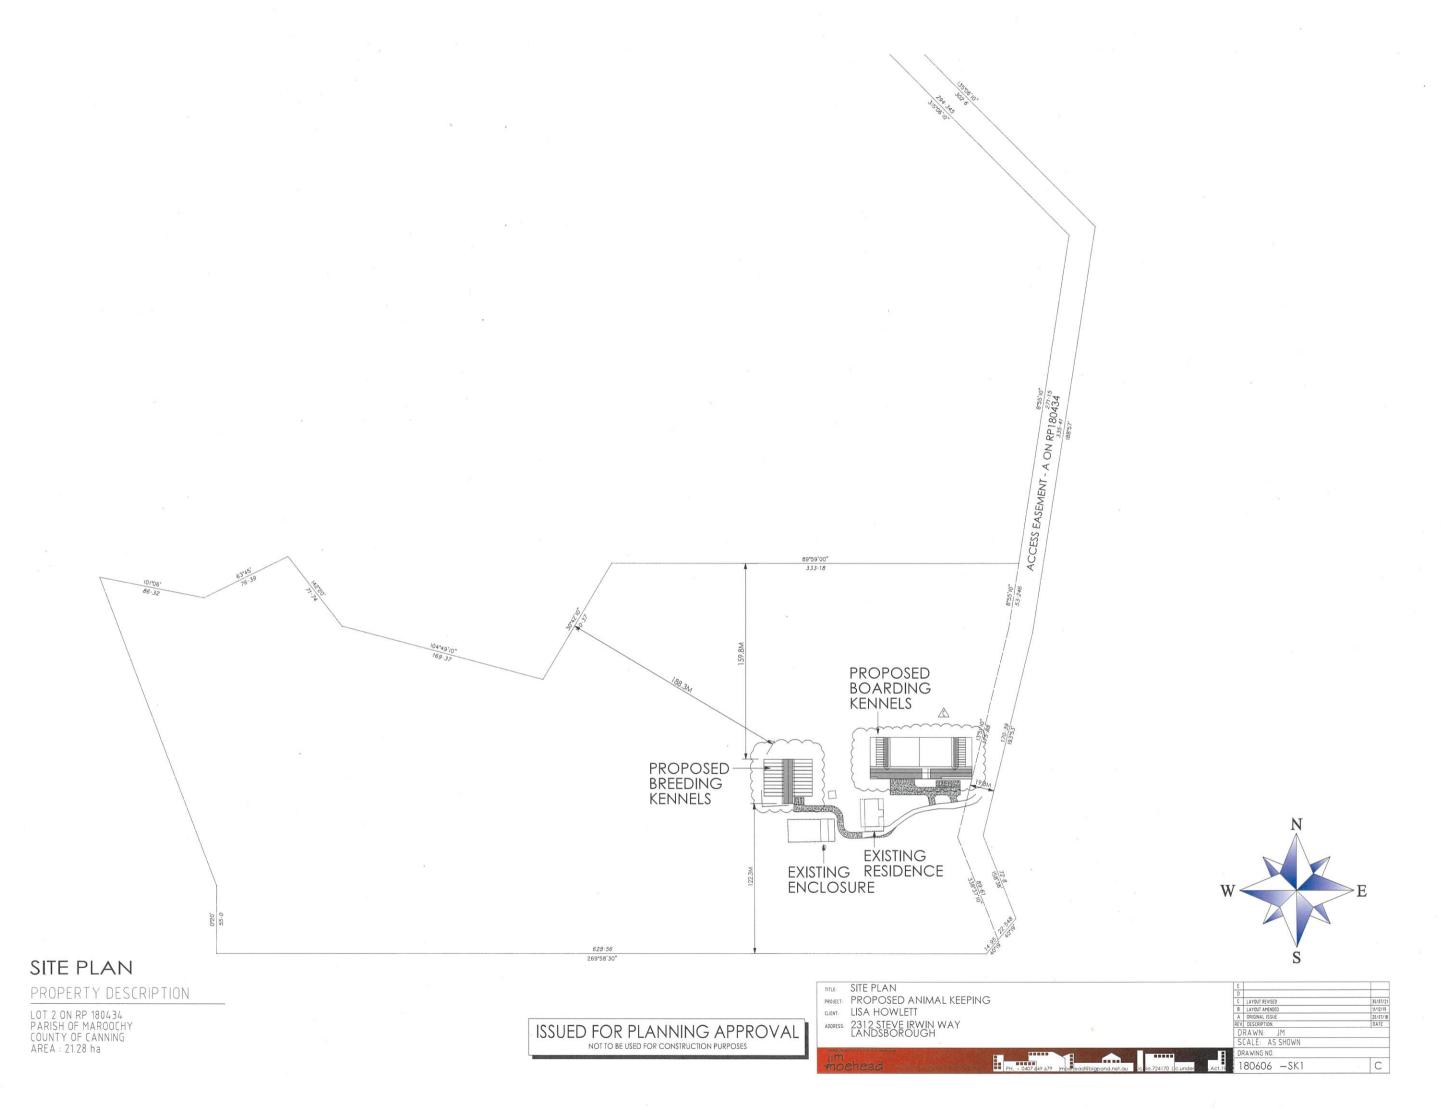




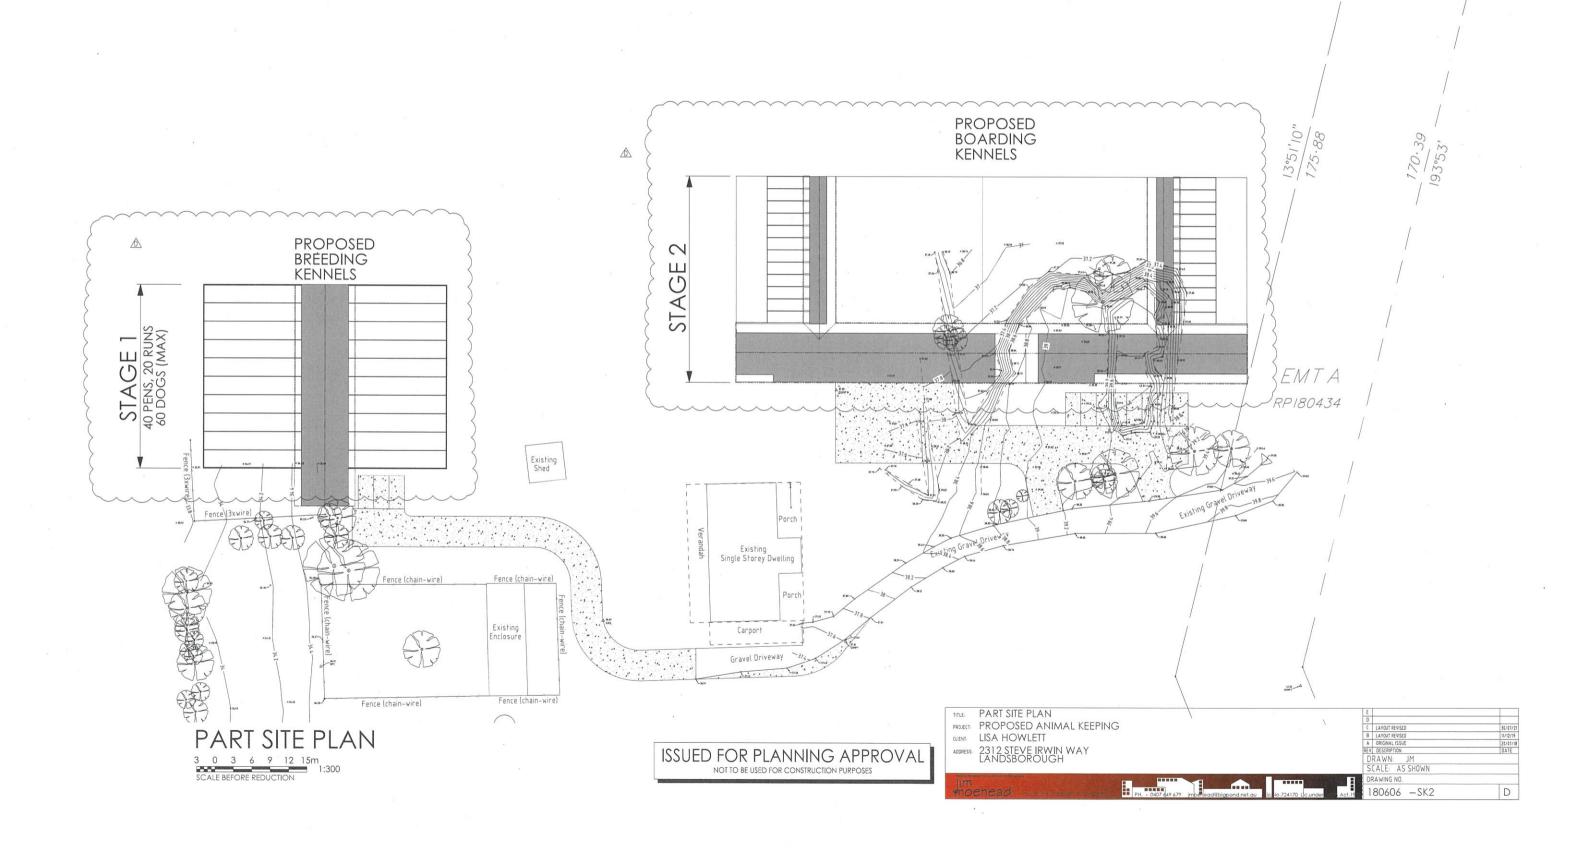



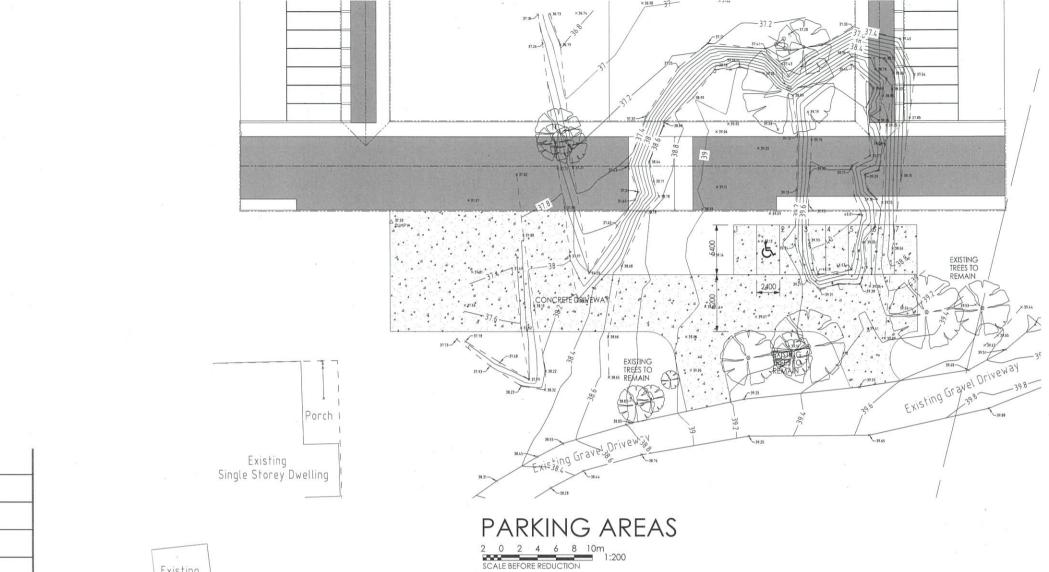

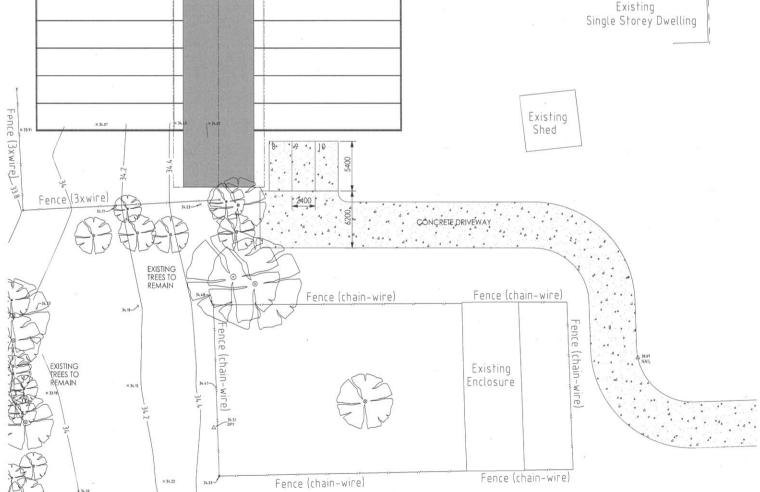



# PARKING AREAS

#### ISSUED FOR PLANNING APPROVAL

PARKING AREAS
PROJECT: PROPOSED ANIMAL KEEPING
CUENT: LISA HOWLETT
ADDRESS: 2312 STEVE IRWIN WAY
LANDSBOROUGH


В

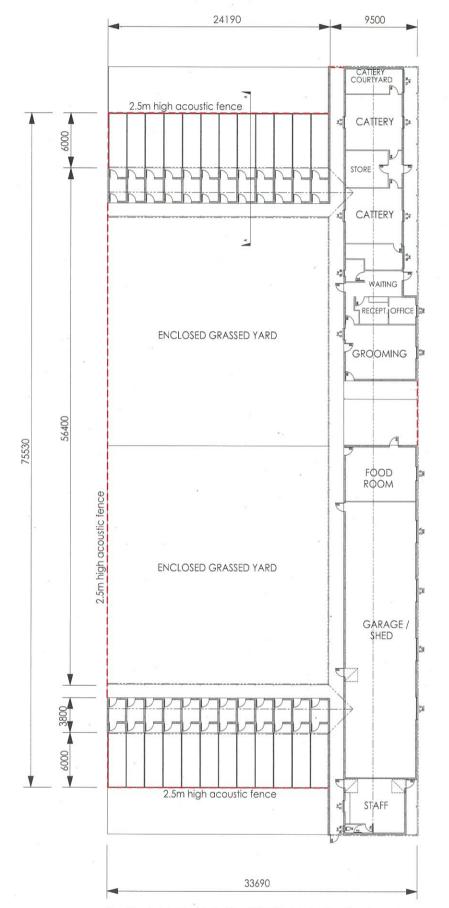


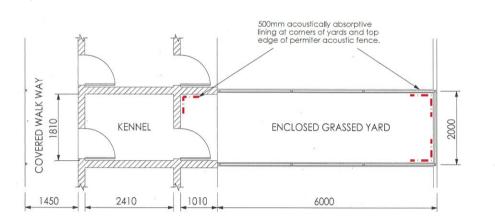

#### TYPICAL KENNEL FLOOR PLAN

5 0 5 10 15 20 25m SCALE BEFORE REDUCTION 1:50

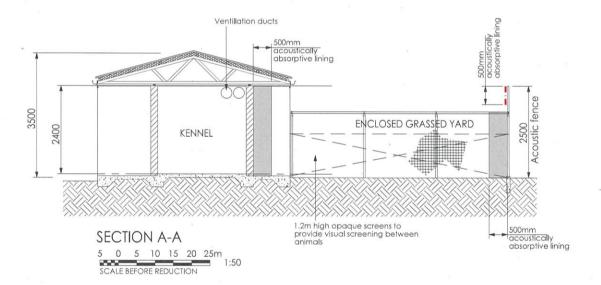

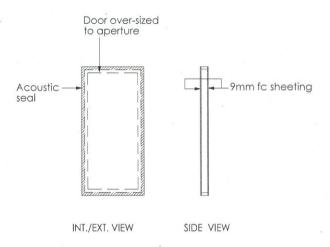

#### KENNEL DOOR DETAILS

90mm timber frame with 9mm fibre cement sheet to both sides. 90mm thick, min. 45 kg/m³ insulation in cavity.
Alternatively 100mm thick insulation slightly compressed. Hinges and latch secured to timber frame to suit.
No penetrations to the cavity are permitted.
All joining surfaces to have non-hardening mastic applied prior to assembling. Door to be oversized to aperture. Acoustic seal to be fixed to either door or around aperture on wall such that compression is achieved when door is latched.

#### **BUILDING CONSTRUCTION NOTES**

External walls to be minimum 150 wide concrete

Internal walls to be light weight (timber or steel

Roof cladding to be selected sheet metal with 100mm mineral wool or fibreglass insulation under sheeting. (Min. 45kg / m³). Ceiling to be 9mm fibre cement with allowance for stick-on acoustically absorbent tiles. All internal wall / ceiling junctions to sealed with approved acoustic sealant / bridging strips.

Ventillation ducts to be run internally.

2.5m high acoustic fence to be as per TMR standard detail for acoustic fencing.

## BOARDING KENNELS / ADMIN / OFFICE SCALE BEFORE REDUCTION 1:200

AREAS: KENNELS - 135 SQM ADMIN/OFFICE - 567 SQM WALKWAYS - 270 SQM

ISSUED FOR PLANNING APPROVAL NOT TO BE USED FOR CONSTRUCTION PURPOSES

BOARDING KENNELS / ADMIN / OFFICE - LAYOUT

PROJECT: PROPOSED ANIMAL KEEPING

CLIENT: LISA HOWLETT


ADDRESS 2312 STEVE IRWIN WAY LANDSBOROUGH




B LAYOUT REVISED
A ORIGINAL ISSUE
EV DESCRIPTION.

DRAWN: JM

SCALE: AS SHOWN RAWING NO.

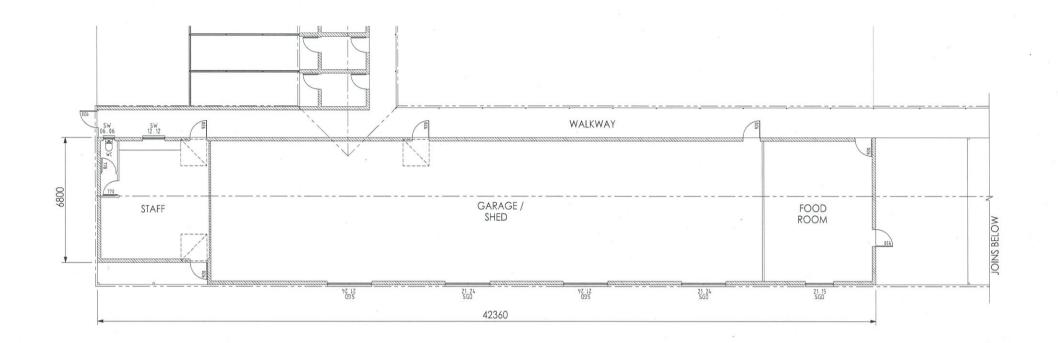

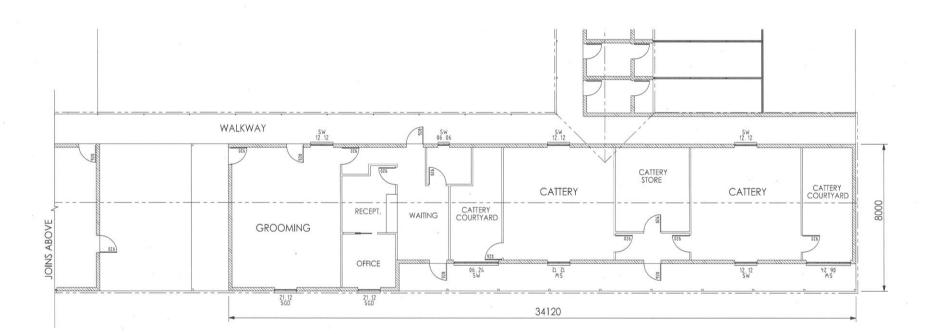



ISSUED FOR PLANNING APPROVAL NOT TO BE USED FOR CONSTRUCTION PURPOSES

	P.			-
		F .		
TITLE OFFICE / ADMIN.LAYOUT		E		-
PROJECT: PROPOSED ANIMAL KEEPING	-	0		-
PROPOSED ANIMAL KEEPING				
CLIENT: LISA HOWLETT		B LAYOUT REVI		30/07/21
		A ORIGINAL IS		20/07/18
ADDRESS: 2312 STEVE IRWIN WAY		REV DESCRIPTION		DATE
address 2312 STEVE IRWIN WAY LANDSBOROUGH		DRAWN:	JM ·	
		SCALE: A	AS SHOWN	
Total Control of the		DRAWING NO	).	
moenead would be acting a family logs and the ph 0407 44 679 imperied@bigpond.net.c	u jc No.724170 Lc.under Act.19	180606	-SK5	В

#### **BUILDING CONSTRUCTION NOTES**


External walls to be minimum 150 wide concrete block.

Internal walls to be light weight (timber or steel stud)

Roof cladding to be selected sheet metal with 100mm mineral wool or fibreglass insulation under sheeting. (Min. 45kg / m³).
Ceiling to be 9mm fibre cement with allowance for stick-on acoustically absorbent tiles.
All internal wall / ceiling junctions to sealed with approved acoustic sealant / bridging strips.

Ventillation ducts to be run internally.

2.5m high acoustic fence to be as per TMR standard detail for acoustic fencing.

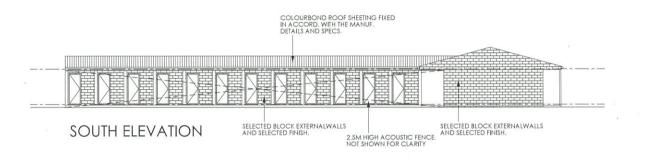

#### BUILDING CONSTRUCTION NOTES

External walls to be minimum 150 wide concrete block.


Internal walls to be light weight (timber or steel stud)


Roof cladding to be selected sheet metal with 100mm mineral wool or fibreglass insulation under sheeting. (Min. 45kg / m²).
Ceiling to be 9mm fibre cement with allowance for stick-on acoustically absorbent tiles.
All internal wall / ceiling junctions to sealed with approved acoustic sealant / bridging strips.

Ventillation ducts to be run internally.

2.5m high acoustic fence to be as per TMR standard detail for acoustic fencing.



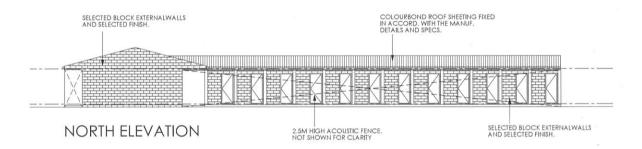

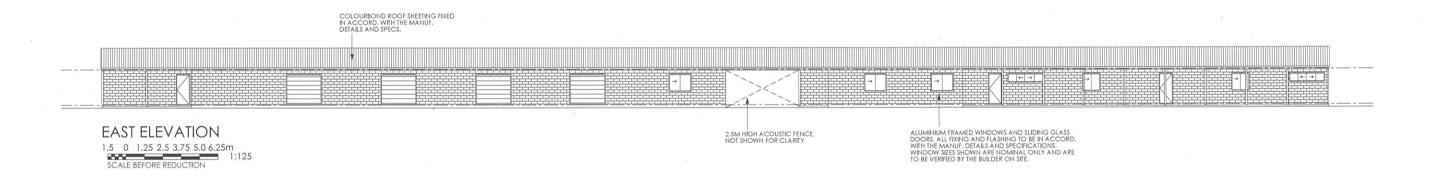

ISSUED FOR PLANNING APPROVAL NOT TO BE USED FOR CONSTRUCTION PURPOSES

BOARDING KENNELS / ADMIN / OFFICE - ELEVATIONS


PROJECT: PROPOSED ANIMAL KEEPING

CLIENT: LISA HOWLETT

ADDRESS: 2312 STEVE IRWIN WAY LANDSBOROUGH




| C | SAMPLE | SAMPLE

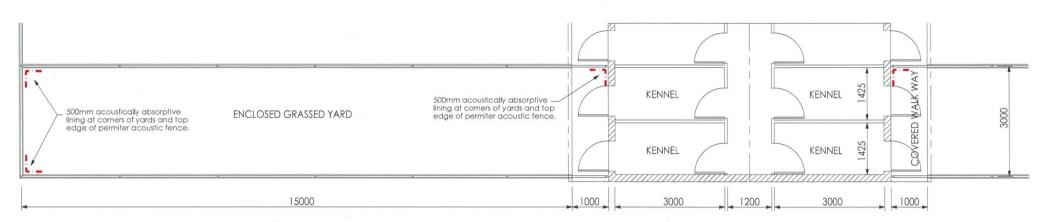

#### TYPICAL KENNEL FLOOR PLAN

5 0 5 10 15 20 25m SCALE BEFORE REDUCTION 1:50

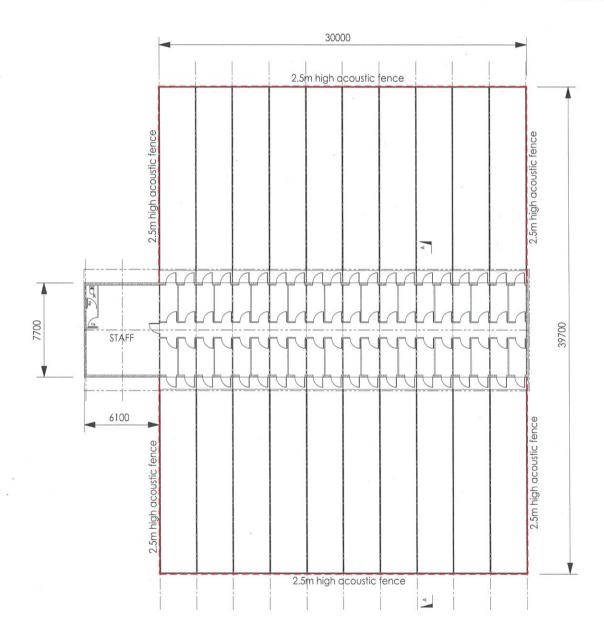


### **BREEDING KENNELS**

1.5 0 1.5 3.0 4.5 6.0 7.5m SCALE BEFORE REDUCTION 1:150

AREAS: KENNELS - 195 SQM STAFF - 46.8 SQM WALKWAYS - 34.5 SQM

ISSUED FOR PLANNING APPROVAL NOT TO BE USED FOR CONSTRUCTION PURPOSES

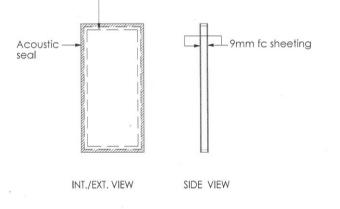

#### KENNEL DOOR DETAILS

Door over-sized to aperture

90mm timber frame with 9mm fibre cement sheet to both sides.
90mm thick, min. 45 kg/m³ insulation in cavity. Alternatively 100mm thick insulation slightly compressed. Hinges and latch secured to timber frame to suit. No penetrations to the cavity are permitted. All joining surfaces to have non-hardening mastic applied prior to assembling. Door to be oversized to aperture. Acoustic seal to be fixed to either door or around aperture on wall such that compression is achieved when door is latched.

#### **BUILDING CONSTRUCTION NOTES**

External walls to be minimum 150 wide concrete block.


Internal walls to be light weight (timber or steel stud)

Roof cladding to be selected sheet metal with 100mm mineral wool or fibreglass insulation under sheeting. (Min. 45kg / m³).
Ceiling to be 9mm fibre cement with allowance for stick-on acoustically absorbent tiles.
All internal wall / ceiling junctions to sealed with approved acoustic sealant / bridging strips.

Ventillation ducts to be run internally.

2.5m high acoustic fence to be as per TMR standard detail for acoustic fencing.

		F				
ITLE:	BREEDING KENNELS - LAYOUT	8				
ROJECT	PROPOSED ANIMAL KEEPING	C	LAYOUT REVISED	30/07/3		
LIENT	LISA HOWLETT	8	LAYOUT REVISED	11/12/19		
		RE	ORIGINAL ISSUE  V. DESCRIPTION.	20/07/* DATE		
DONCAS	2312 STEVE IRWIN WAY LANDSBOROUGH		RAWN: JM			
		-	CALE: AS SHOWN			
The same of the sa						
mo	PH 0407 49 679   Imperied@bigpond.net.au   Ic No.724170   Lc.under 100   Act. 15		180606 -SK7	C		
mod	ehead ship a baga salah salah salah salah p.H 0427 449 679   mp.mead8bigpond.net.au   ic ho.724170 Lic.under 81 Act. IV		180606 -SK7			

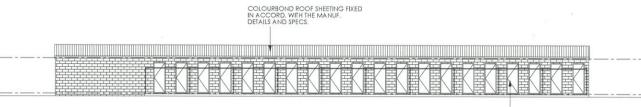



EAST ELEVATION



COLOURBOND ROOF SHEETING FIXED IN ACCORD. WITH THE MANUF, DETAILS AND SPECS. SELECTED BLOCK EXTERNALWALLS AND SELECTED FINISH. **WEST ELEVATION** 

1.5 0 1.25 2.5 3.75 5.0 6.25m SCALE BEFORE REDUCTION 1:125

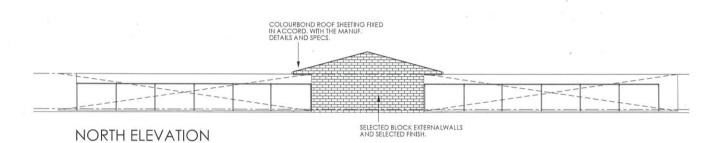

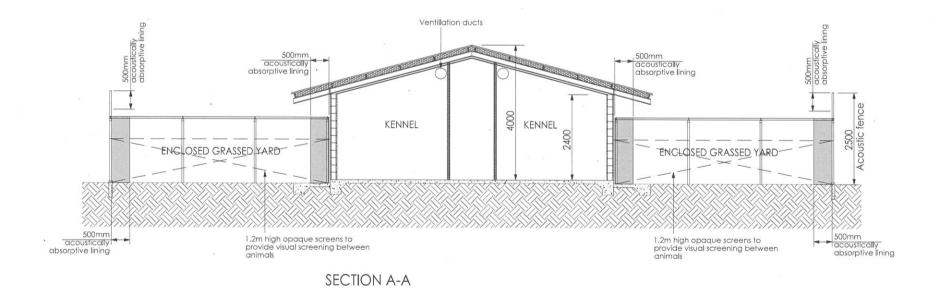

5 0 5 10 15 20 25m SCALE BEFORE REDUCTION 1:50

#### **BUILDING CONSTRUCTION NOTES**

External walls to be minimum 150 wide concrete block.

Internal walls to be light weight (timber or steel stud)


Roof cladding to be selected sheet metal with 100mm mineral wool or fibreglass insulation under sheeting. (Min. 45kg / m³).
Ceiling to be 9mm fibre cement with allowance for stick-on acoustically absorbent tiles. All internal wall / ceiling junctions to sealed with approved acoustic sealant / bridging strips.

Ventillation ducts to be run internally.


2.5m high acoustic fence to be as per TMR standard detail for acoustic fencing.


ISSUED FOR PLANNING APPROVAL NOT TO BE USED FOR CONSTRUCTION PURPOSES

BREDDING KENNELS - ELEVATIONS PROPOSED ANIMAL KEEPING LISA HOWLETT  RRSS 2312 STEVE IRWIN WAY LANDSBOROUGH		E				
		D	LAYOUT REVISED	30/1		
		В	LAYOUT REVISED	11/1		
		A	ORIGINAL ISSUE	20/0		
			DESCRIPTION. RAWN: JM	DA		
			SCALE: AS SHOWN			
PH 0407/49 679 impire and 8 big pand and au ic No. 724170 Uc under Act. 19		DRAWING NO.				
		1	80606 -SK8	C		

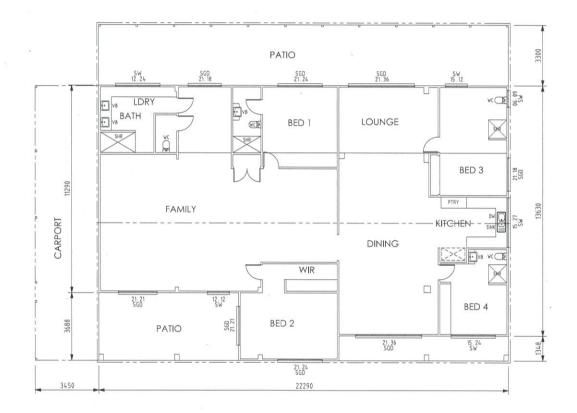

EXISTING RESIDENCE

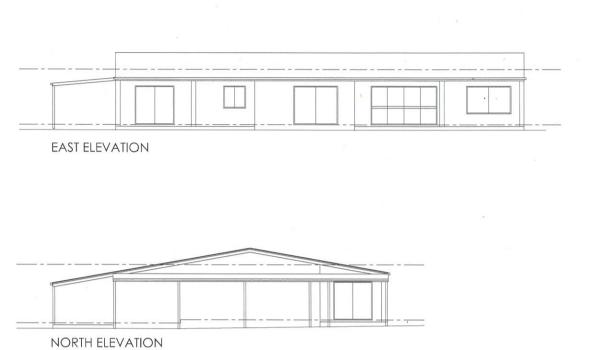

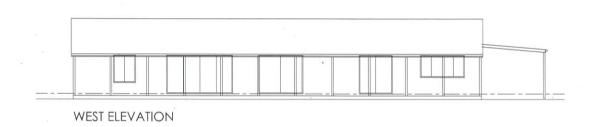



ISSUED FOR PLANNING APPROVAL NOT TO BE USED FOR CONSTRUCTION PURPOSES

		F		
LE	EXISTING RESIDENCE - PLAN & ELEVATIONS	Ε		
		C		_
ENT:	LISA HOWLETT	8		
DRESS:	2312 STEVE IRWIN WAY	REV	ORIGINAL ISSUE  / DESCRIPTION.	20/0' DAT
	2312 STEVE IRWIN WAY LANDSBOROUGH		RAWN: JM	
0.00		-	CALE: AS SHOWN	
ım		-	RAWING NO.	



Attachment One

**Vegetation Protection Covenant** 

Prepared by Sunshine Coast Council

September 2021