

Caloundra Administration Building Repurposing Project Preliminary Design Report



Q1939 STAGE 3

DATE 25th February

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Introduction

Wilson Architects and associated Consultant Team were appointed in December 2019 to provide a Preliminary Design for the proposed re-purposing of the Caloundra Administration Building (CAB). The project involves the conversion of an existing Class 5 Office Building constructed in 1994 into a modern library and community facility, Customer Service Centre and Council Administration Offices (Class 9b Public building with Class 5 Office).

This Report is Stage 3 of the engagement to provide the Preliminary Design Report and Preliminary cost opinion.

Library Workshop

Wilson Architects conducted a full day workshop with SCC Heritage and Culture and Project Management Team members on the 29th of January 2020. The Draft Library Brief was issued on the 14th April. Subsequent meetings on the 4th June, 2nd & 29th July have firmed up the Library Design Brief.

Caloundra Community and Creative Hub Workshop

Wilson Architects were involved in a full day workshop managed by Jacobs on the 3rd of March 2020 and the follow-up online review on the 7th July, with reference to the CCH project. We have continued to maintain liason with Jacobs and are aware of the ongoing process for the design of the precinct.

PCG Meetings

PCG Meetings including Councillors have been held on the 27.02.20, 14.07.20, 18.09.20 and 02.11.20

First Nations Consultation

SCC and Wilson Architects met with a representative of the Kabi Kabi people on 3rd March 2020 to identify and explore opportunities for employment, engagement and representation in the proposed refurbishment of the Caloundra Administration Building and site. The process is ongoing with the SCC.

Due Diligence Report

This report should be read alongside the CAB RP Stage 2 Due Diligence Report.

executive summary

Masterplan

The intention of the Caloundra Centre Masterplan is to create a community and creative hub in the centre of Caloundra including a new contemporary District Library, new Caloundra Regional Gallery, new Town Square and public realm connecting Bulcock Beach through to The Events Centre. The new precinct will create a cultural heart space for gathering, events and celebrations.


Stage 1 is the Caloundra Administration Building Repurposing.

It is proposed to refurbish the existing Caloundra Administration Building to house the Caloundra District Library as well as a Customer Service Centre, Community Facilities and Council Administration Offices.

The Library will be the primary tenant of the building and it is envisaged that the new Caloundra District Library will occupy space over all levels, with the largest footprint on the Ground and first floor levels.

The SCC Customer Service Centre is housed within the Library and occupies space on the ground floor of the building as a secondary service point.

In addition the building will also house community use meeting rooms, Councillor offices and SCC administration office space on Level 3.

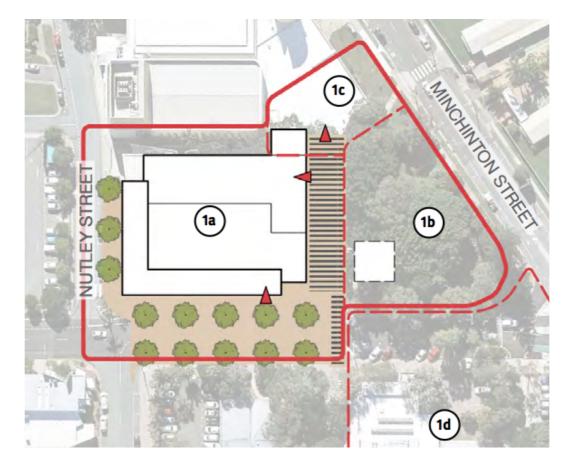



- Refurbish and extend existing building to house a new Caloundra District Library.
- Activate adjacent Bill Venardos Park.
- Connect through to the The Event Centre.
- Shared pedestrian zone to Omrah Ave




Caloundra Administration Building circa 1995 Architects Peddle Thorpe and Harvey





Caloundra Administration Building 2019

building upgrade diagrams

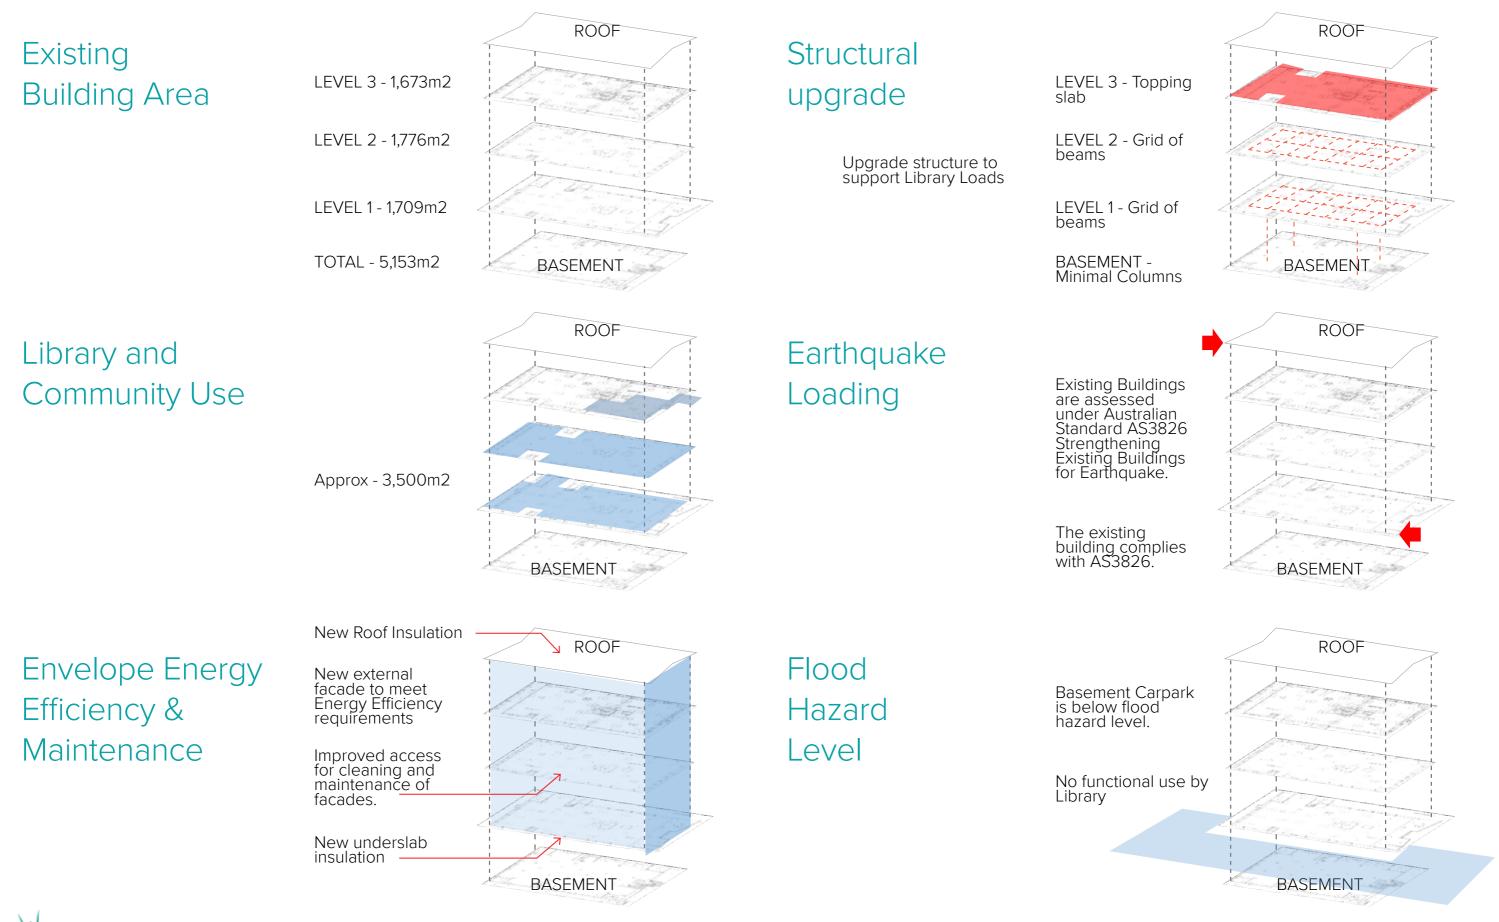


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Issue A

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building upgrade diagrams



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Issue A

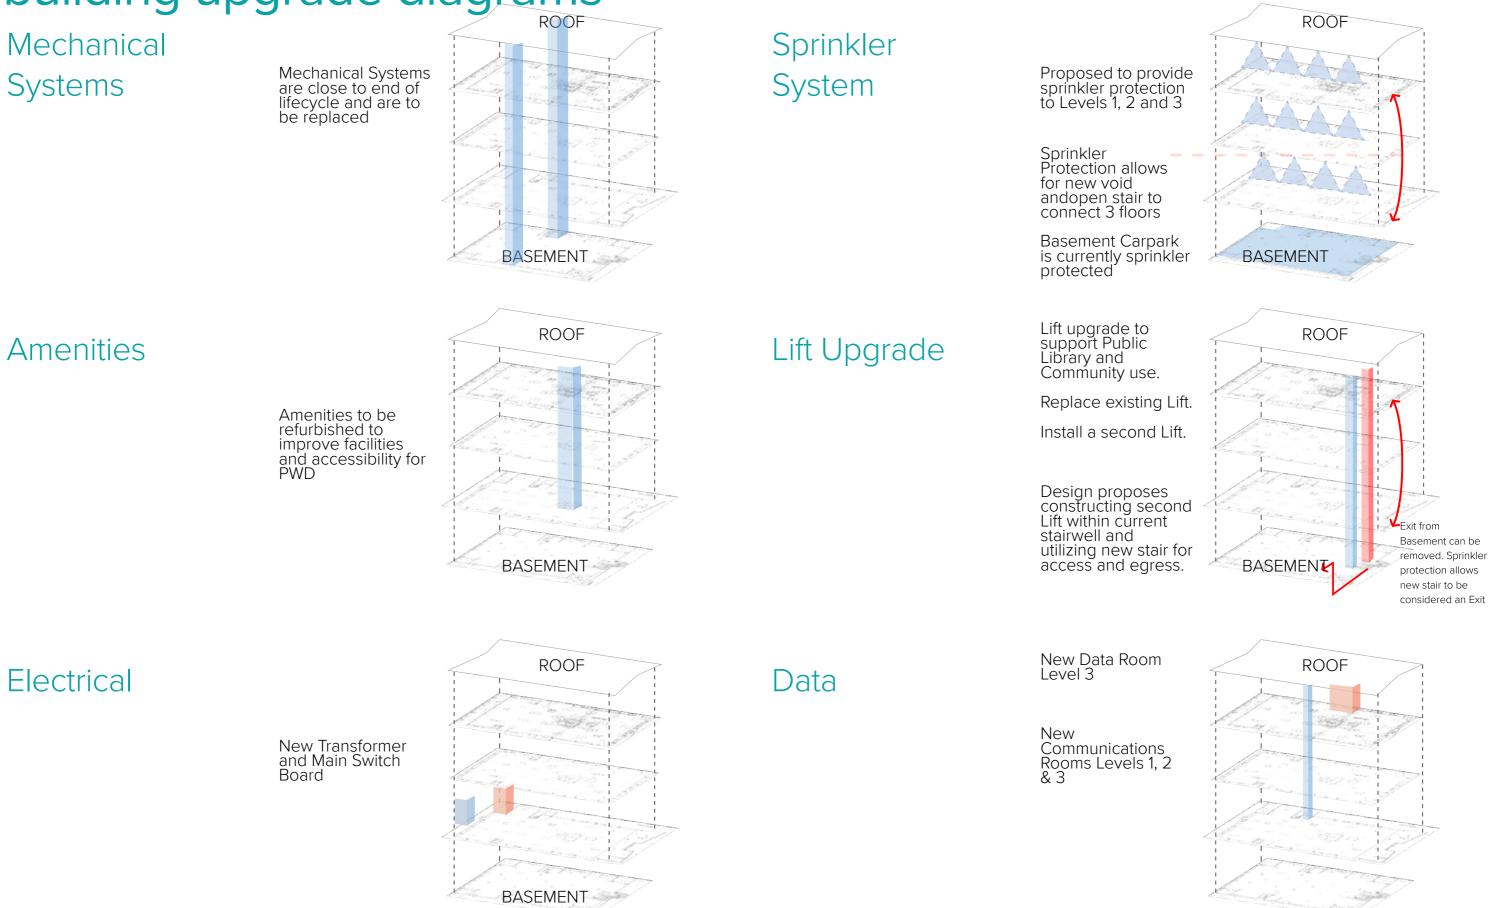5

project values

As part of our Design Process, we develop a set of built form values. This provides us a framework to to measure our design against throughout the process. These built form values are established by reviewing the client brief, workshop feedback and the Caloundra Library user group requirements and project aspirations in the "Our Library, Our Place' document.

reinforce_

community through the design by facilitating education, social and cultural connectivity

connect_

the library visually and physically with the local landscape, people and knowledge


support_

the needs of the local community by providing a safe space that is welcoming and comfortable

transform_

an existing building into a place that establishes a vibrant, sustainable and creative community heart for Caloundra




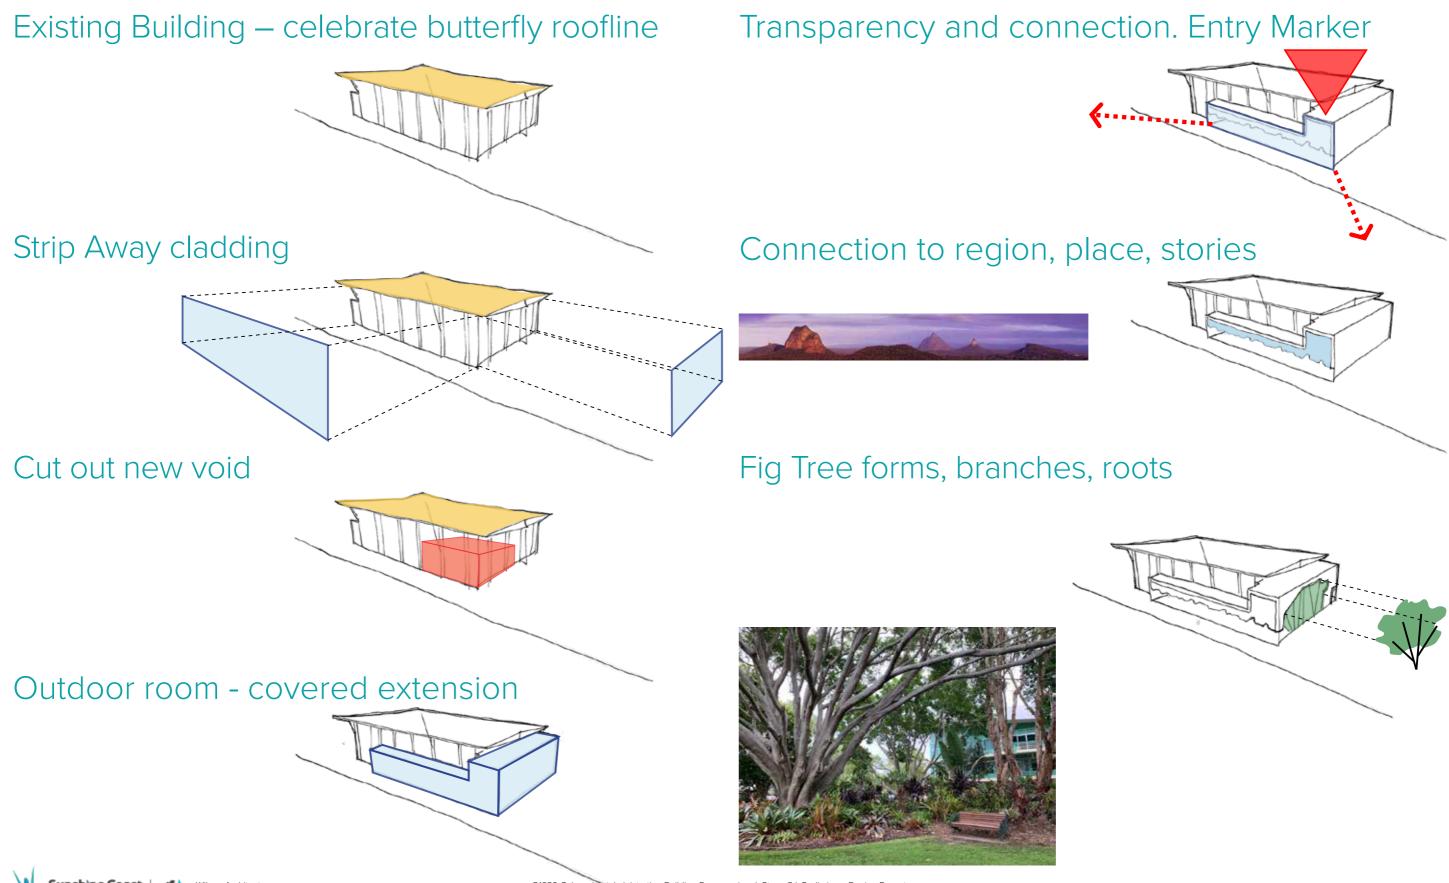

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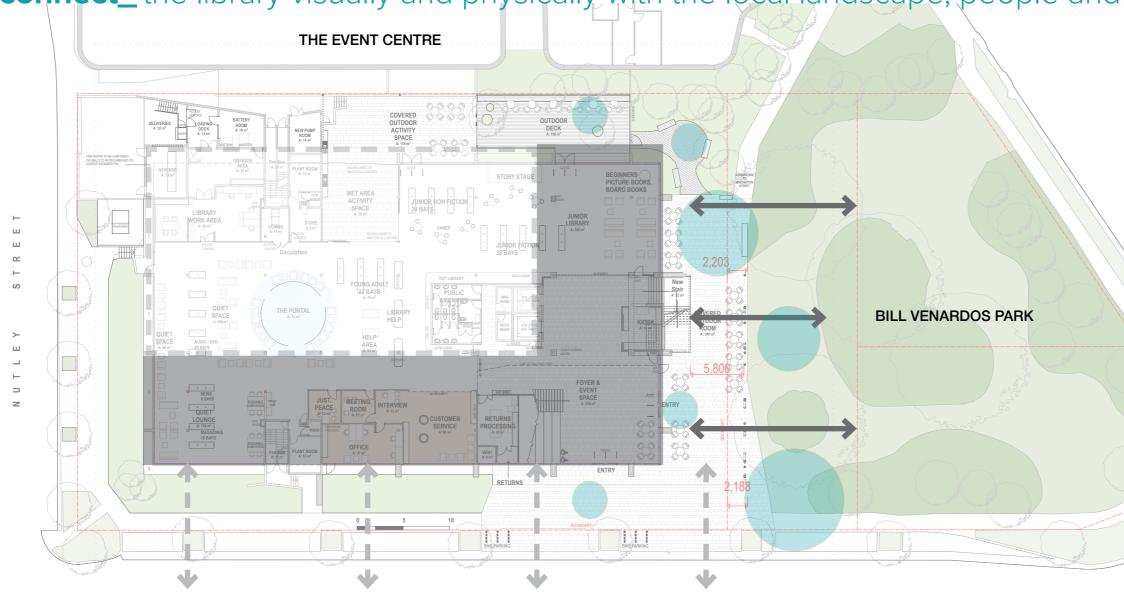
reinforce_community through the design by facilitating education, social and cultural connectivity



• develop a heart to the building that connects the inside to the outside

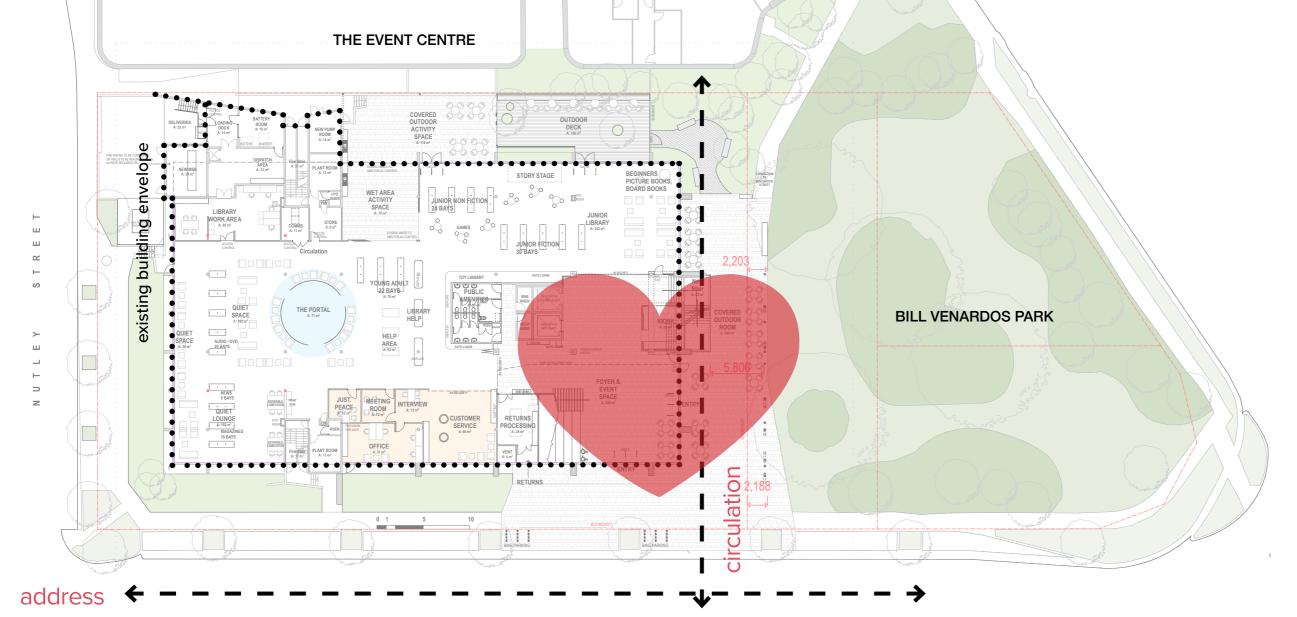• facilitate a series of spaces that allow the public to meet and gather

• promote civic and community space through acknowledging local history, culture and place in the design



connect_ the library visually and physically with the local landscape, people and knowledge

- increase transparency of the facade
- open up the existing building to Bill Venardos Park and bring the landscape into the library
- through the design, increase accessibility and visual connection to activity in the library, encouraging use and ownership of place
- bring the landscape into the building


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bringing the landscape into the building library program visual + physical connection to Bill Venardos Park

> visual connection (transparency) to future town square


building edge transparency_ active edges

support_the needs of the local community by providing a safe space that is welcoming and comfortable

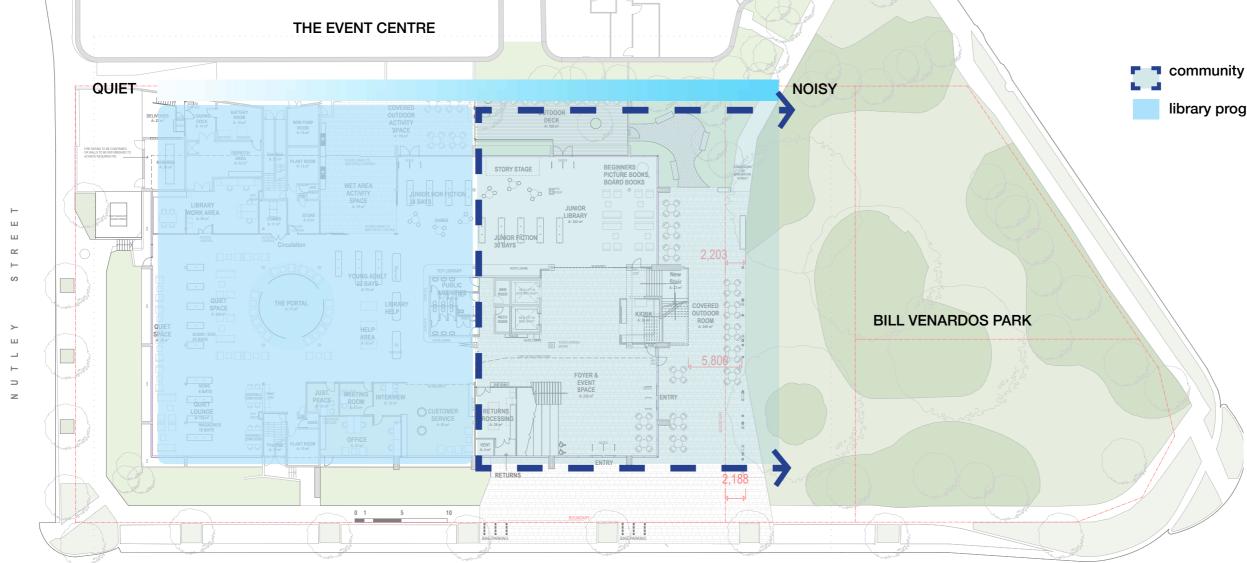


• the design should include diversity of spaces; quiet areas away from noisy and active spaces to the civic park edge, promoting activity, exploration, experimentation and discovery

- the library should house a diverse collection, technology and social spaces
- It is a place where learning is encouraged, supporting all types of communities including students, staff, special interest groups, visitors and local business
- materials, lighting and furniture should create a comfortable envronment that people want to be in
- wayfinding through the building should be clear and not confusing to visitors

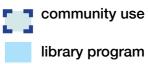

transform_an existing building into a place that establishes a vibrant, sustainable and creative community heart for Caloundra

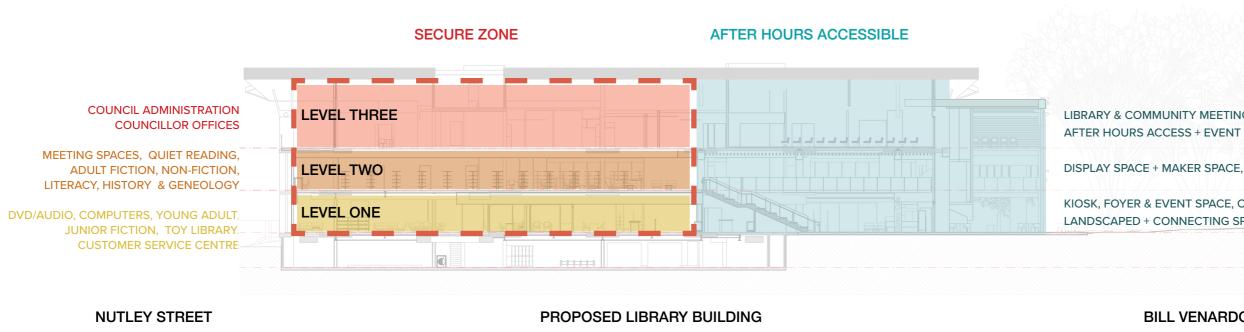

- the design should reflect the Caloundra Masterplan values and be the catalyst for the precinct development
- sustainability can be reflected not only in the materials used, but also the way the building and library operates
- designing flexible spaces that can adapt over time
- the library building will transform the current use and facilitate events, learning and collaboration across a number of Library Communities

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LIBRARY & COMMUNITY MEETING ROOMS WITH AFTER HOURS ACCESS + EVENT SPACES

KIOSK, FOYER & EVENT SPACE, COVERED OUTDOOR AREA, LANDSCAPED + CONNECTING SPACES

BILL VENARDOS PARK

interface with Bill Venardos Park

Our proposed design creates an generous outdoor room on the Eastern side of the building to encourage Public use of the facility. It creates:

- A generous covered entry to the Library building.


- Activation of the ground plane with Kiosk and covered areas for reading, dining and meeting.

- A spacious and direct connection through to The Event centre to allow for gathering before and after events.

- An 'all-weather' covered area to encourage movement out into and use of Bill Venardos Park.


- An outdoor covered event space for the Library and Community.

The building projects approximately 2.2m over the existing lot boundary, up to the edge of the existing concrete pathway. The building area over the boundary is approximately 73.5m2.

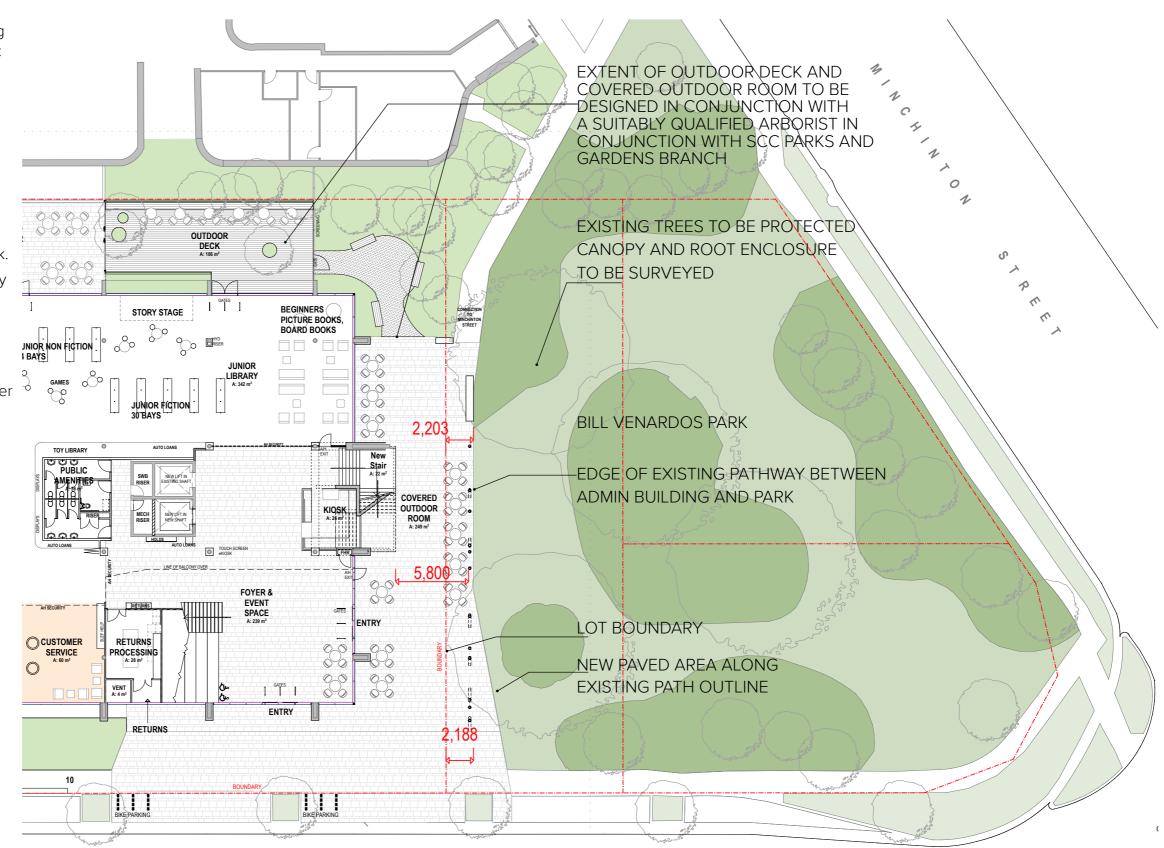



interface with Bill Venardos Park

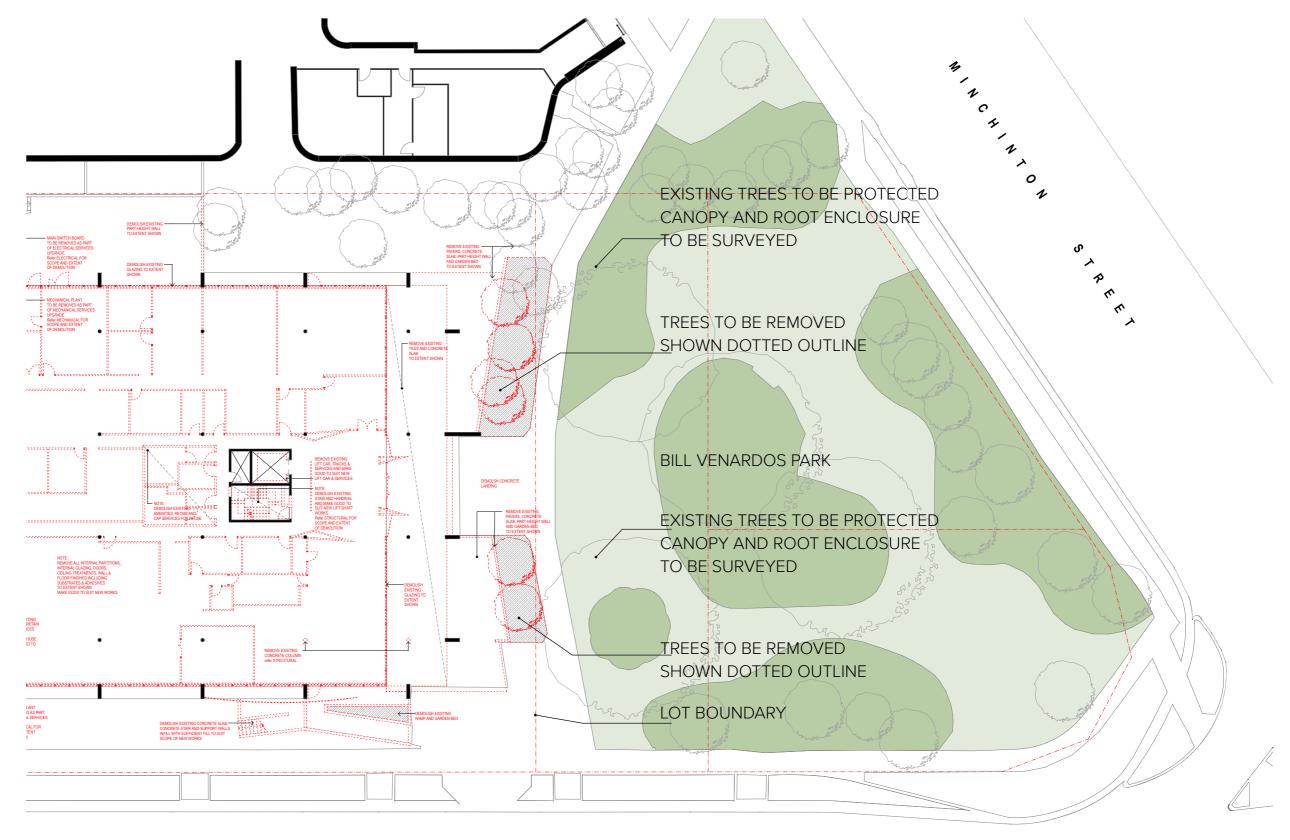

Plan showing Demolition

AVENUE OMRAH

Wilson Architects

 \supset



interface with Bill Venardos park outdoor room option

The following comparison option brings the building extent to within the limit of the existing Lot boundary, reducing the scale and proportion of the Covered Outdoor Room. The impact of the reduction affects:

- Entry to the Library, less protected from weather

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- Visibility and connection through to The Event Centre is reduced.
- Upper level Community meeting rooms are reduced in size.

- Ground level activation with reduced seating areas, meeting spaces.

- Reduced covered outdoor Library and Community event space.

proposed

reduced

JUNIOR

LIBRARY A: 342 m²

TOUCH SCREEL eKIOSK


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FOYER &


EVENT

SPACE

A: 239 m

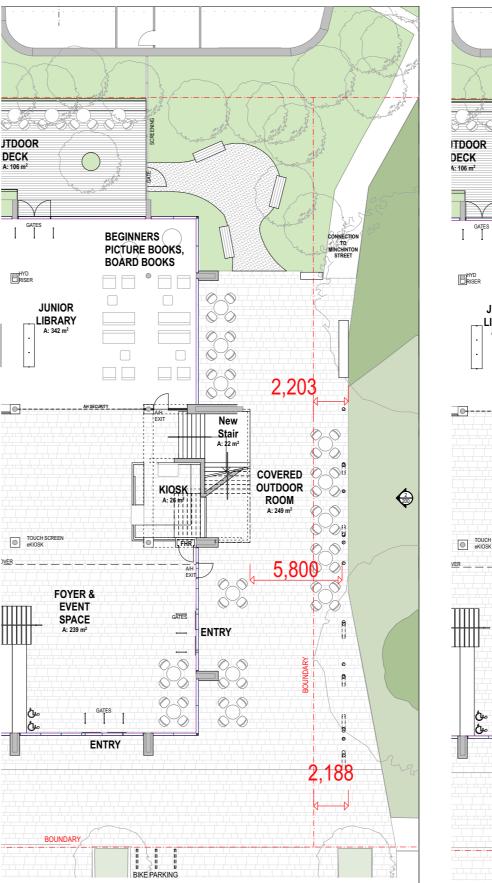


level 1 floor plan

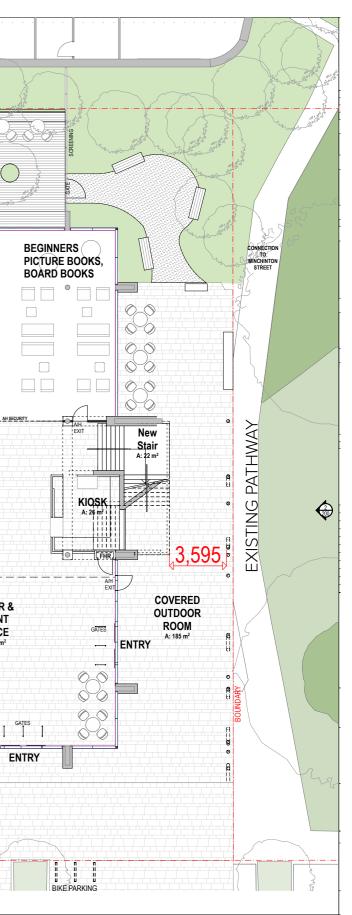

interface with Bill Venardos park outdoor room option proposed

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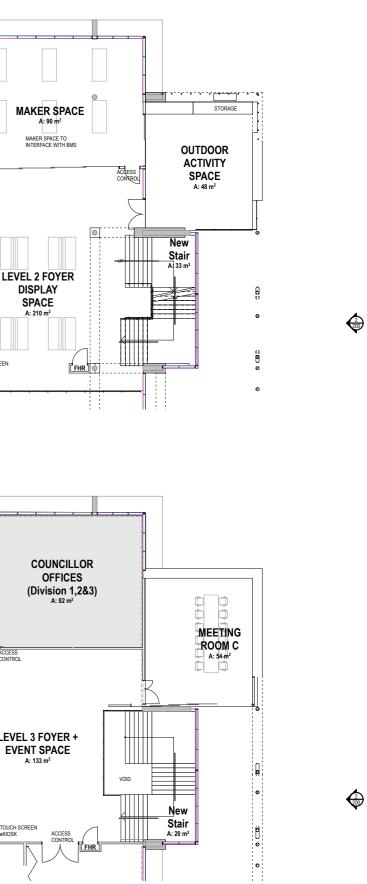
level 2 floor plan

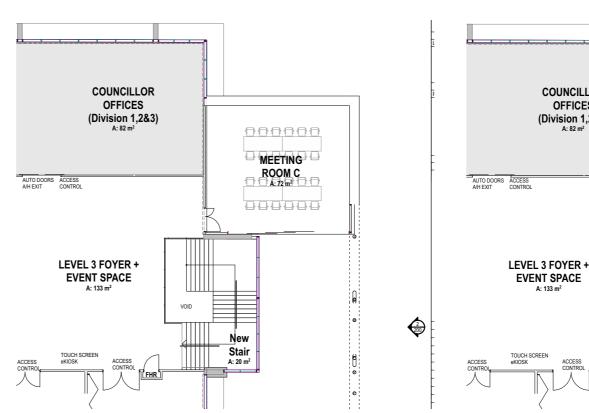


level 3 floor plan



reduced



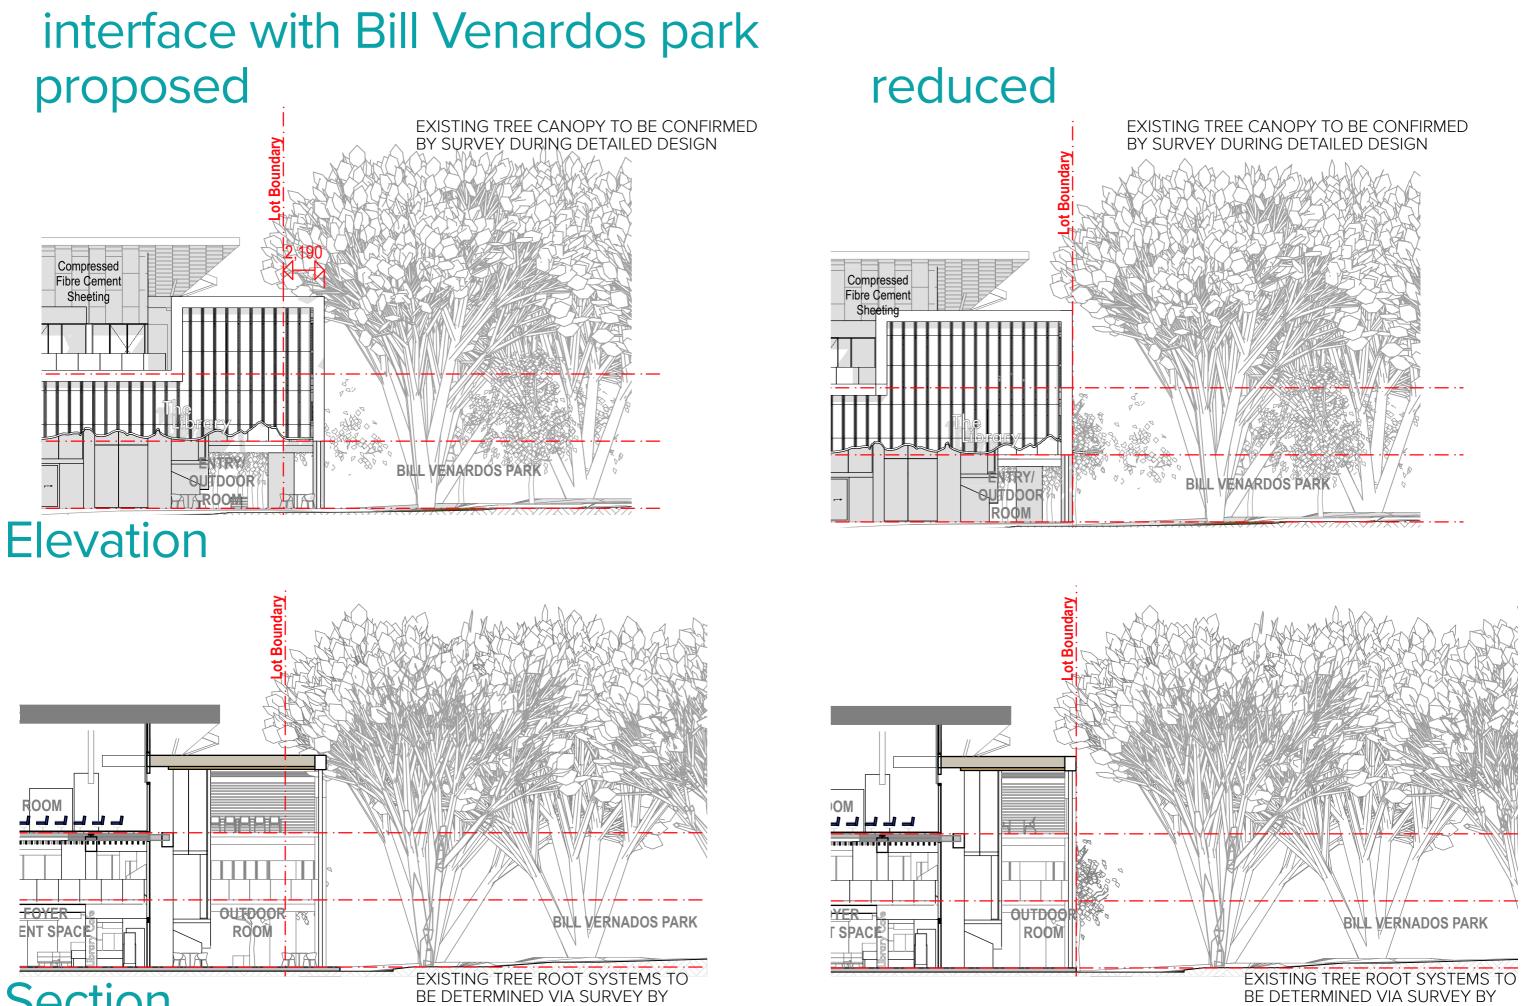



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QUALIFIED ARBORIST

BE DETERMINED VIA SURVEY BY QUALIFIED ARBORIST

interface with Bill Venardos park proposed

reduced





Omrah Ave




Outdoor Room





demolition plans

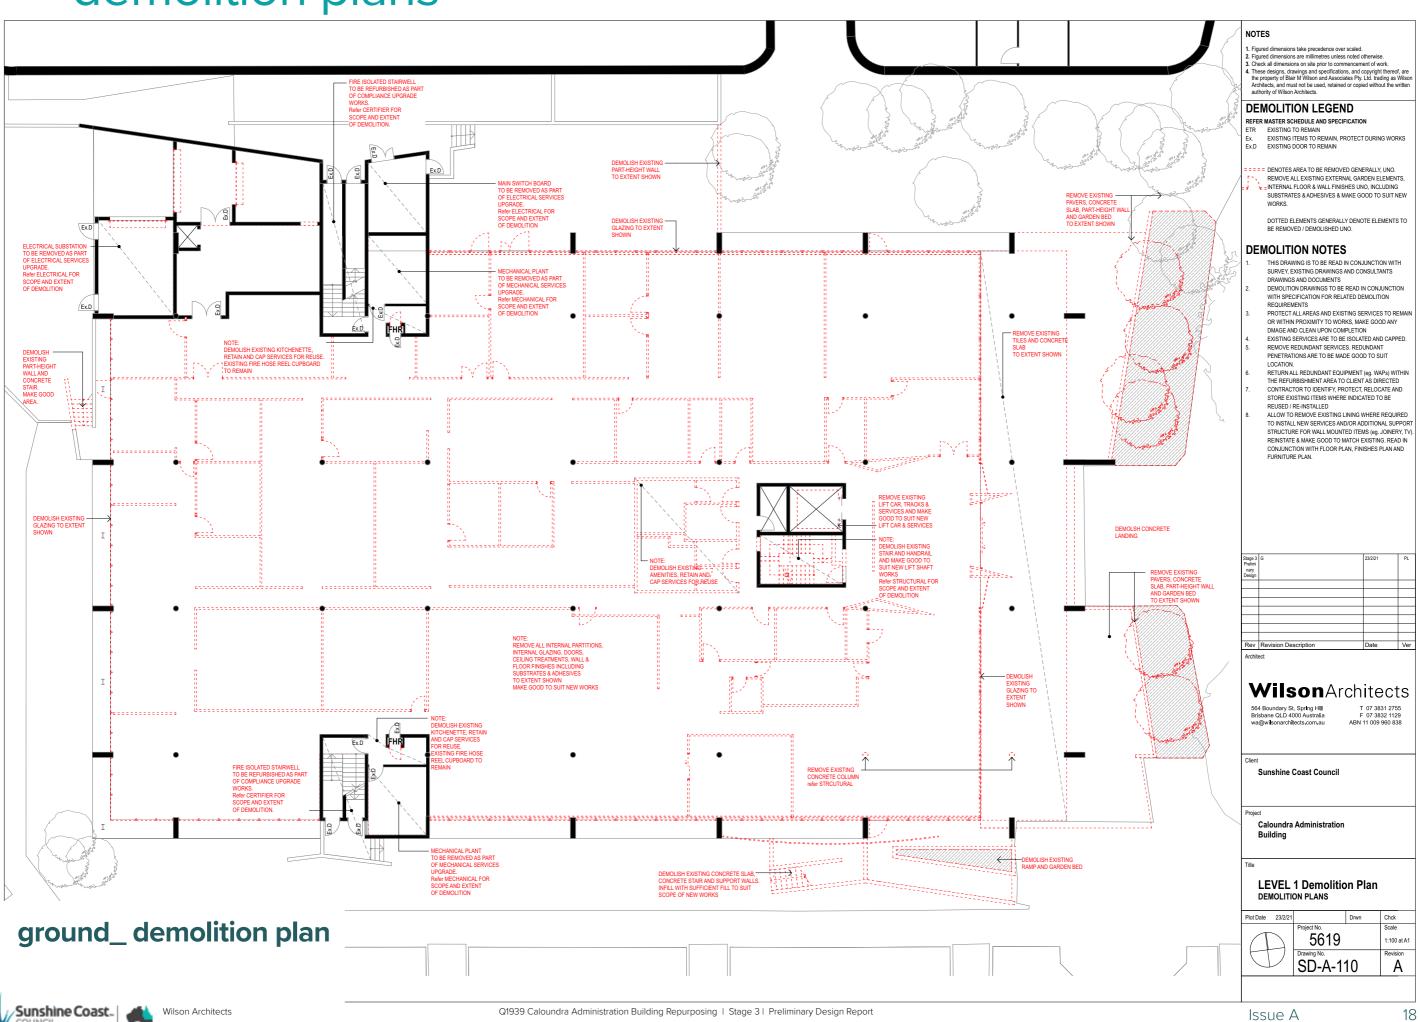

COUNCIL




level one_ demolition plan



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Issue A

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level two_ demolition plan

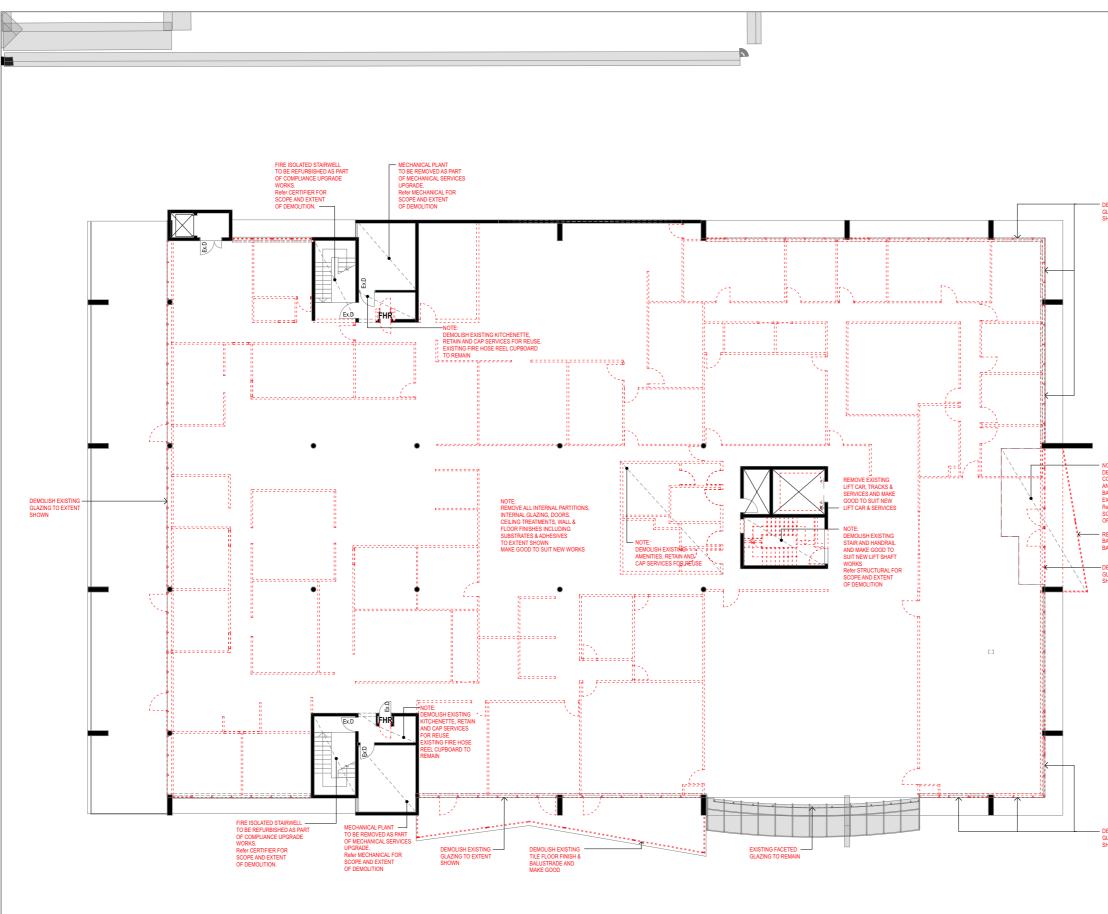

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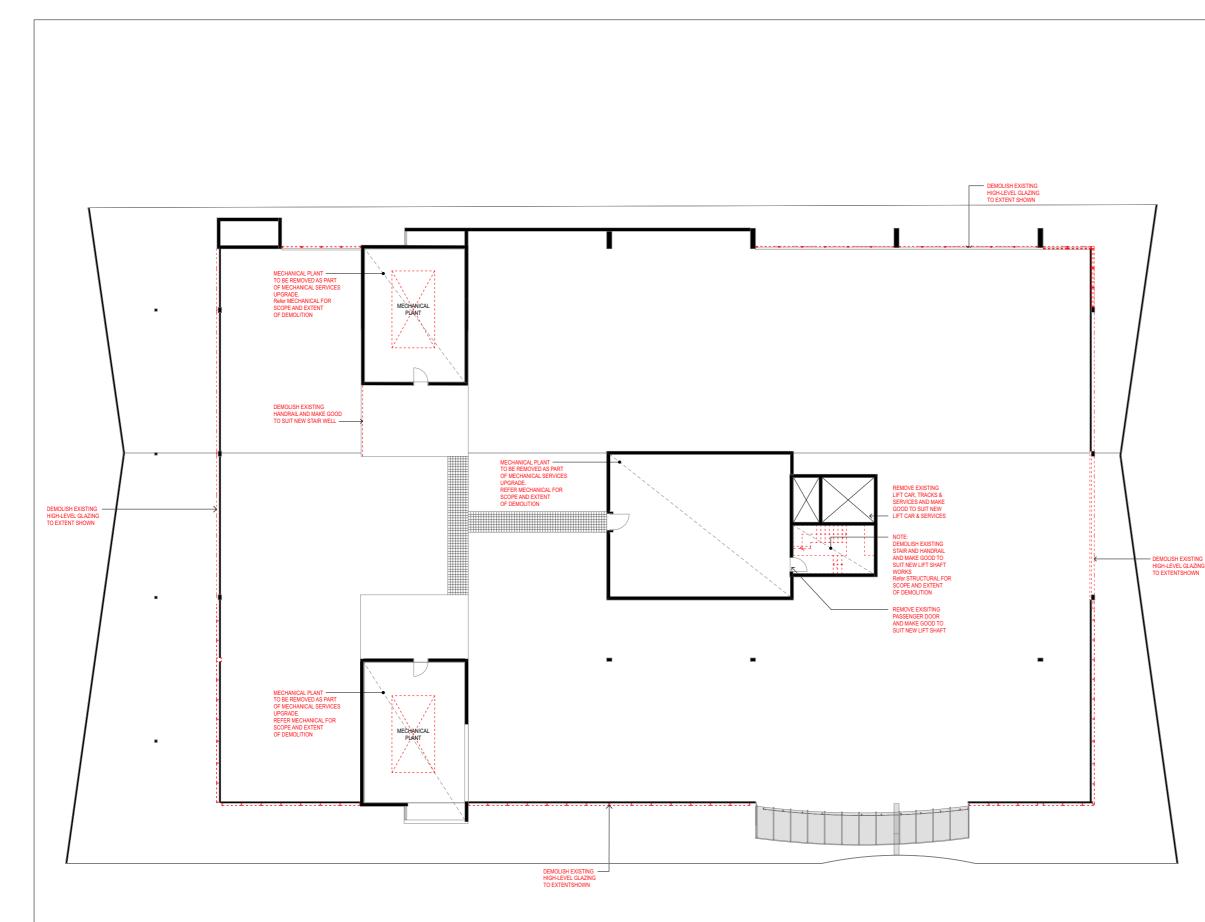
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plant room level_demolition plan

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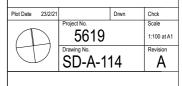
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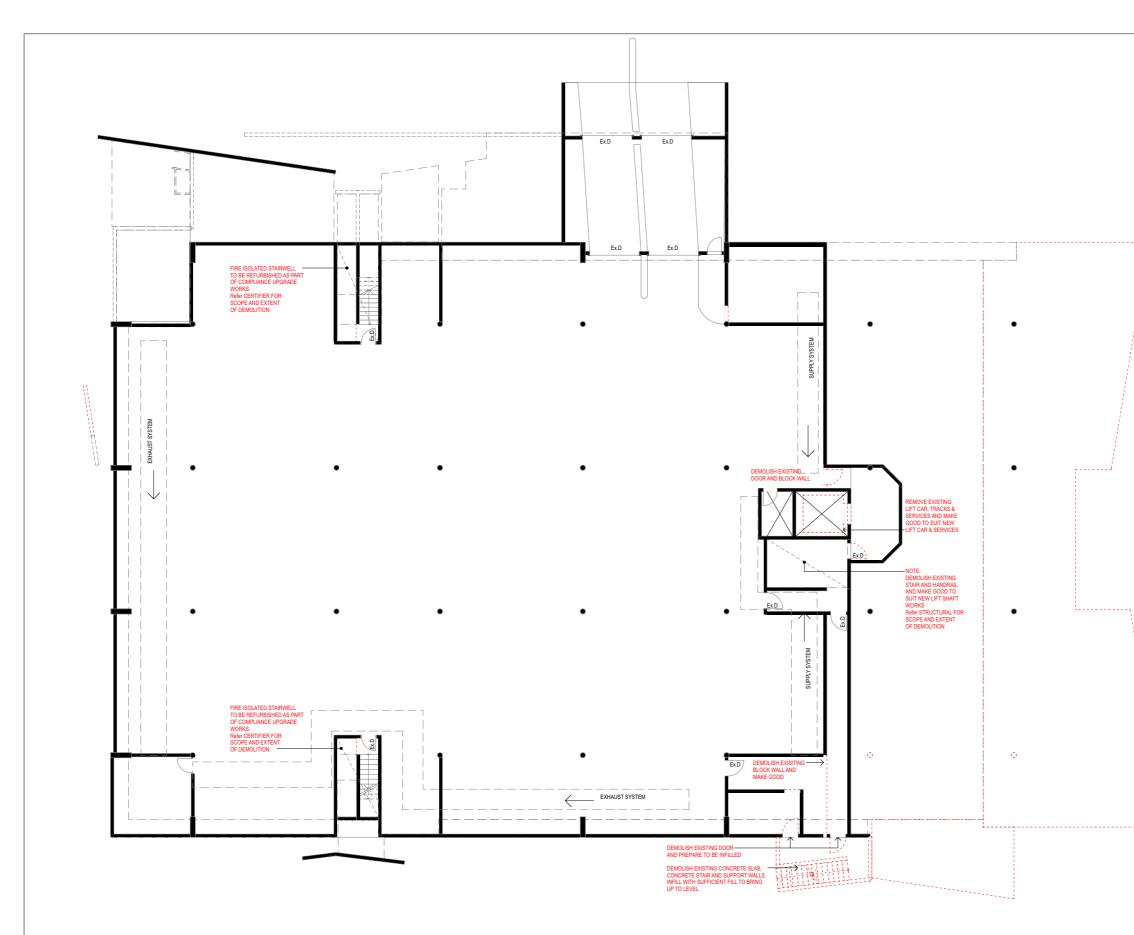
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Caloundra Administration Building

PLANT ROOM LEVEL Demolition Plan DEMOLITION PLANS





plant room level_demolition plan

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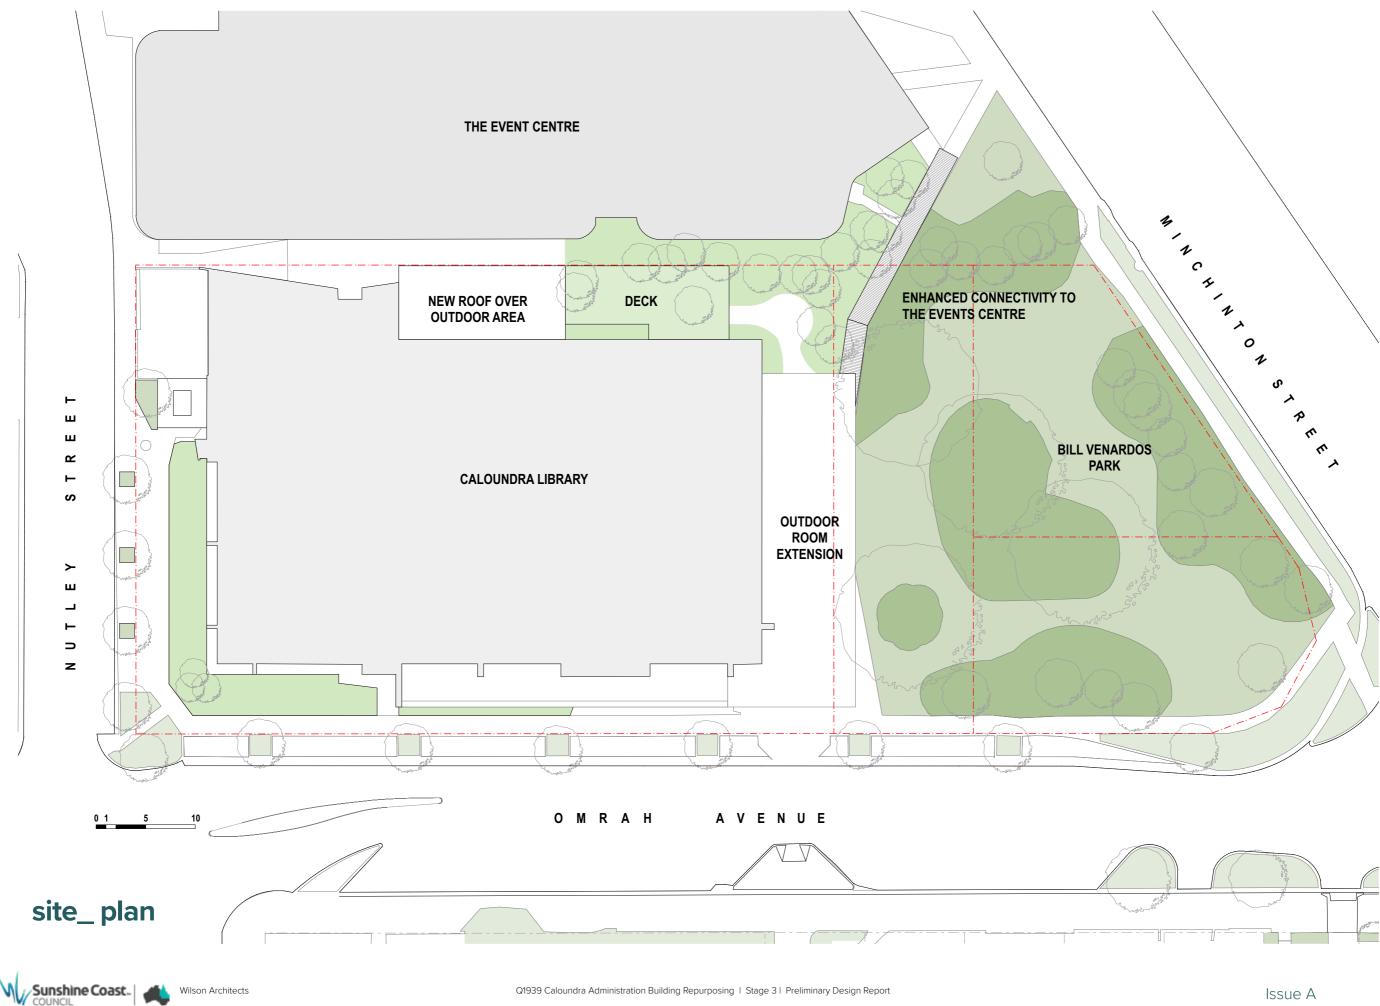
Sunshine Coast Council

Caloundra Administration Buildina

BASEMENT Demolition Plan DEMOLITION PLANS




concept plans




Issue A

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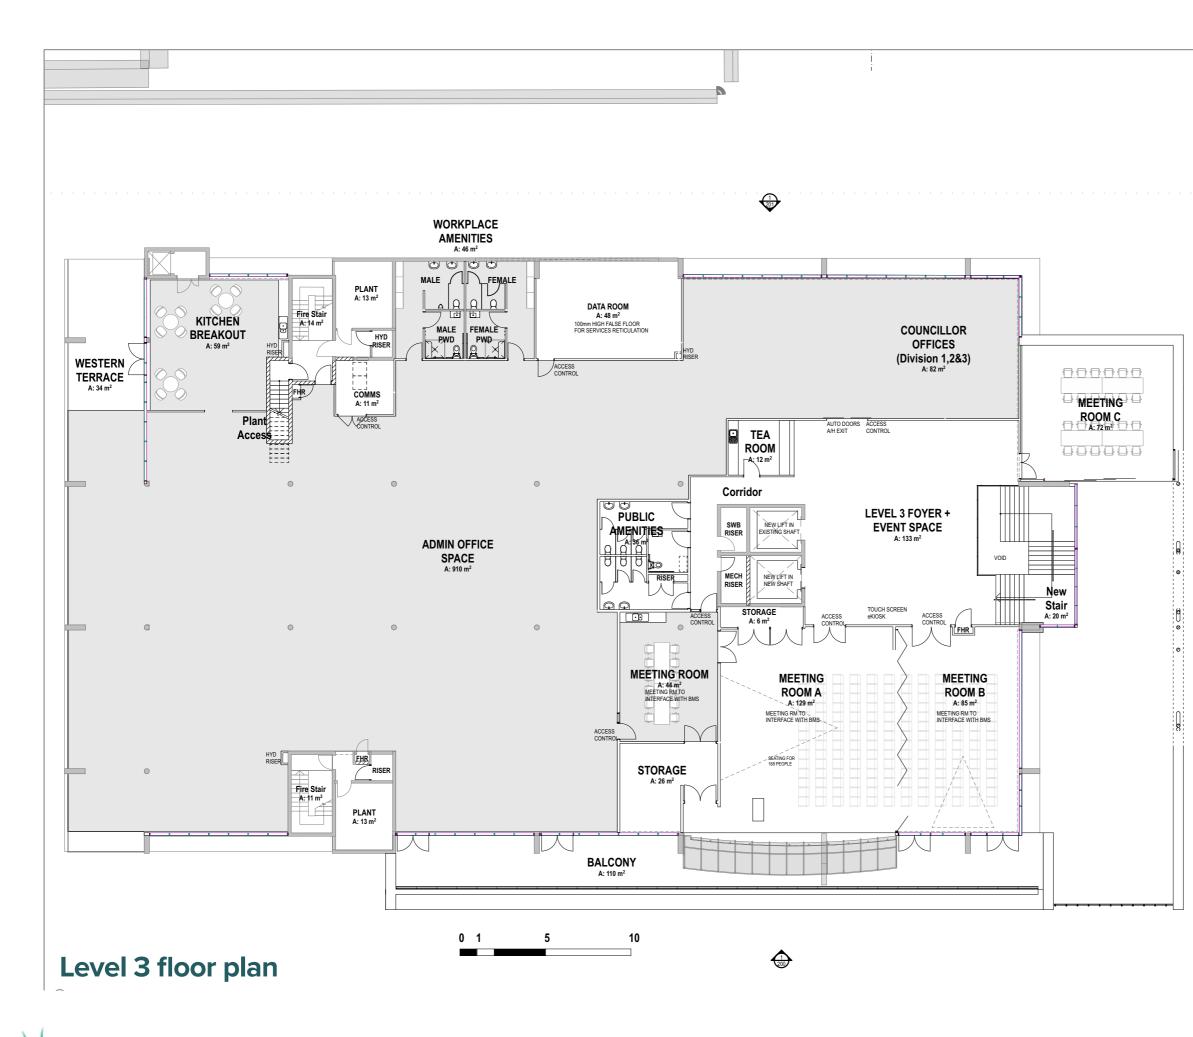

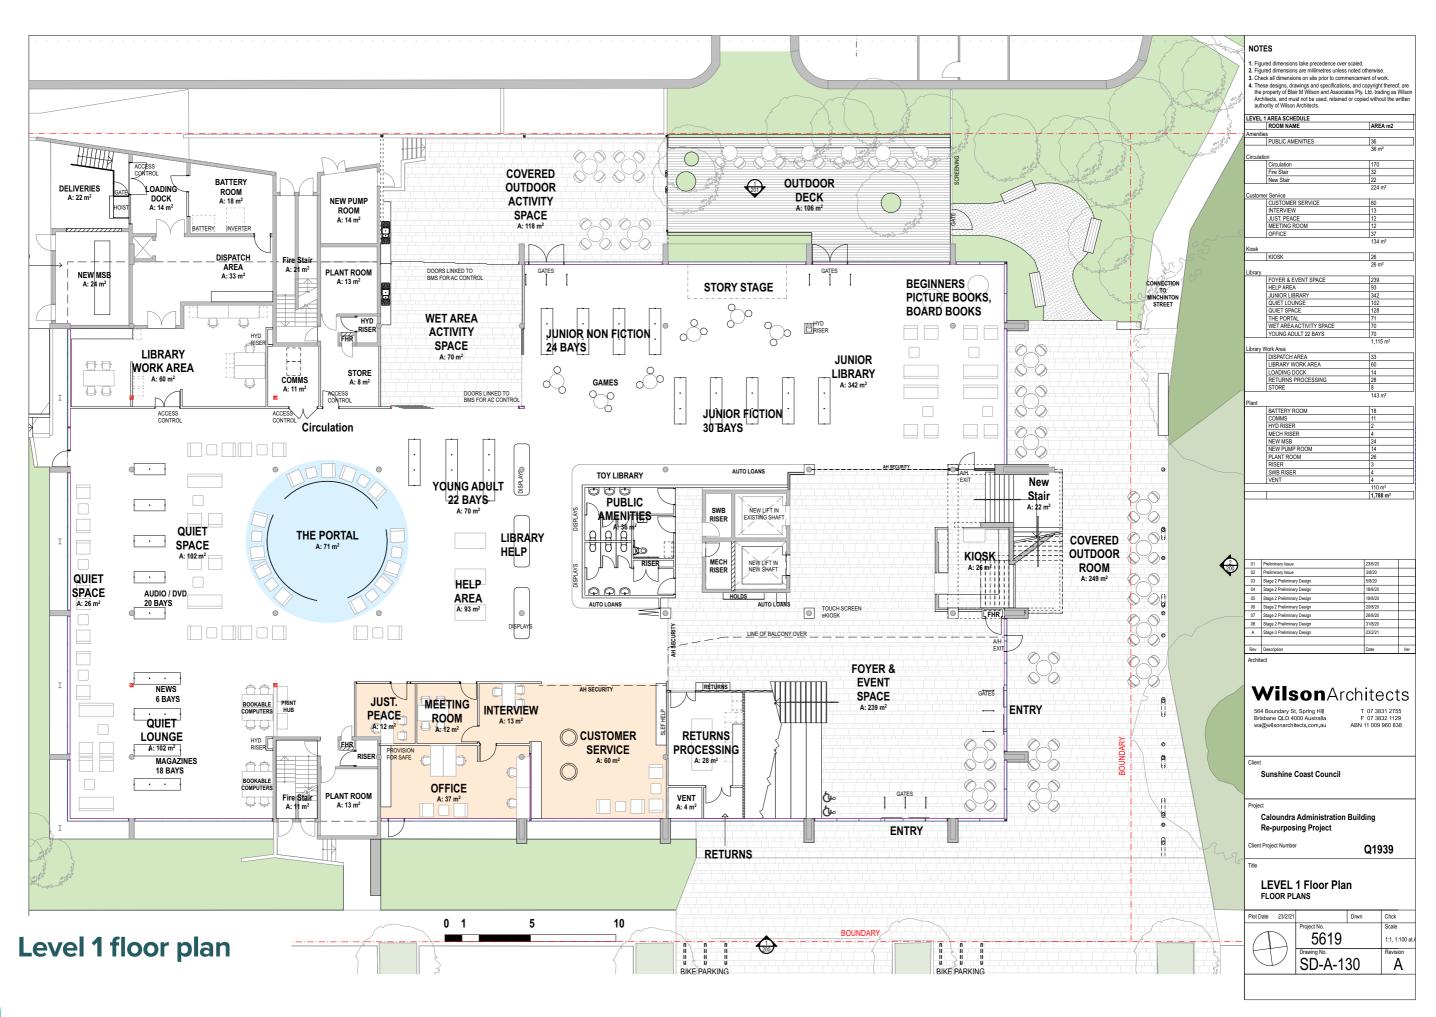
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Sunshine Coast. Wilson Architects COUNCIL


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			36 m ²	_
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		Fire Stair New Stair	22	
		Stair	20	_
	Library		283 m ²	-
		ADULT FICTION 128 BAYS LEVEL 2 FOYER DISPLAY SPACE	201 210	
		LOCAL HISTORY & GENEALOGY	161	
		RESEARCH M1.1	18	_
		M1.2 M1.3	18	_
		M1.4 M1.5	18	_
		M1.6	18	_
		MAKER SPACE MAKER STORE	90 15	
		MEETING ROOM	17	
		NON FICTION 96 BAYS PODCAST SOUND RECORD	149 16	_
		QUIET SPACE READING LOUNGE	47 59	_
	L	TIERED SEATING	45	_
	Library V	l /ork Area	1,118 m ²	
		LIBRARY BREAK ROOM LIBRARY PROCESSING & STORAGE	41 73	
	L	STORE	7	
	Plant		121 m ²	
		COMMS HYD RISER	2	
		MECH RISER	4 40	_
		PLANT RISER	3	_
		SWB RISER	4 64 m ²	_
			1,622 m ²	
	01 P	reliminary Issue	3/8/20	
200	02 S	tage 2 Preliminary Design	5/8/20	
		tage 2 Preliminary Design tage 2 Preliminary Design	18/8/20 19/8/20	_
		tage 2 Preliminary Design	20/8/20 26/8/20	
		tage 2 Preliminary Design tage 2 Preliminary Design	31/8/20	_
	A S	tage 3 Preliminary Design	23/2/21	
	<u> </u>	escription	Date	Ver
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			N 11 009 960 838	
	L			
	Client			
	S	unshine Coast Council		
	Project			_
		aloundra Administration Bu e-purposing Project	ilding	
	Client P	roject Number	Q1939	
	Title	EVEL 2 Floor Plan		
		LOOR PLANS		
	Plot Dat	e 23/2/21 Dru Project No.	vn Chck Scale	
4	/	5619	1:1, 1:10	10 at 1
è	16	Drawing No.	Revision	
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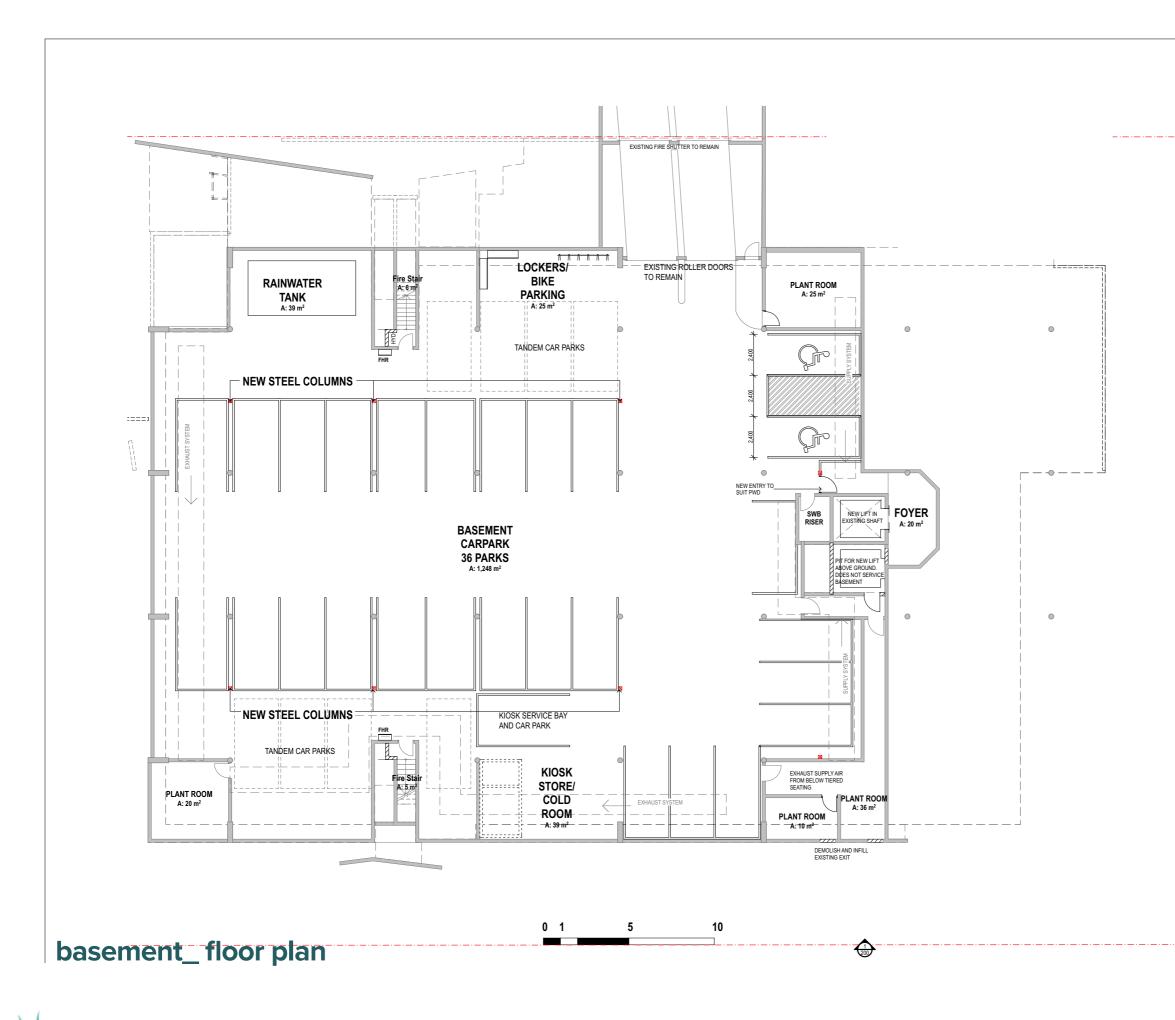
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3. Che	ck all dimensions on site prior to commen se designs, drawings and specifications, a	cement of w	ork.		
the p	property of Blair M Wilson and Associates hitects, and must not be used, retained or	Pty. Ltd. tra	ding as Wilson		
auth	ority of Wilson Architects.				
LEVEL	3 AREA SCHEDULE ROOM NAME	AREA n	2		
Adminis	ADMIN OFFICE SPACE	910			
	COUNCILLOR OFFICES (Division 1,2&3)	82			
	KITCHEN BREAKOUT MEETING ROOM	59 44			
	WORKPLACE AMENITIES	46 1,141 m	2		
Amenitie	PUBLIC AMENITIES	36			
	TEA ROOM	12 48 m ²			
Circulati	on Corridor	20			
	Fire Stair New Stair	25			
Librony	New Stall	65 m ²			
Library	LEVEL 3 FOYER + EVENT SPACE	133			
	MEETING ROOM A MEETING ROOM B	129 85			
	MEETING ROOM C STORAGE	72 32			
Plant		451 m²			
	COMMS DATA ROOM	11 48			
	HYD RISER MECH RISER	2			
	PLANT Plant Access	26			
	RISER SWB RISER	3			
		101 m ²	2		
		1,000 m			
02 5 03 5 04 5	Preliminary Issue Stage 2 Preliminary Design Stage 2 Preliminary Design Stage 2 Preliminary Design	3/8/20 5/8/20 18/8/20 19/8/20			
	Stage 2 Preliminary Design Stage 2 Preliminary Design	20/8/20 26/8/20			
	Stage 2 Preliminary Design Stage 3 Preliminary Design	31/8/20			
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564 Bris wa@	VilsonArc Boundary St, Spring Hill bane QLD 4000 Australia @wilsonarchitects.com.au A		31 2755 32 1129		
Client	Sunshine Coast Council				
Project Caloundra Administration Building Re-purposing Project					
	Caloundra Administration B	uilding			
C F	Caloundra Administration B	uilding Q19	139		
Client F Title	Caloundra Administration B Re-purposing Project	Ţ)39		
Client F Title	Caloundra Administration Bi Re-purposing Project Project Number LEVEL 3 Floor Plan LOOR PLANS	Ţ	39		
Client F Title	Caloundra Administration Bi Re-purposing Project Project Number LEVEL 3 Floor Plan LOOR PLANS Re 23/2/21 0	Q19	Chck Scale		
Client F Title	Caloundra Administration Bi Re-purposing Project Project Number LEVEL 3 Floor Plan FLOOR PLANS te 23/2/21 C	Q19	Chck Scale 1:1, 1:100 at A		
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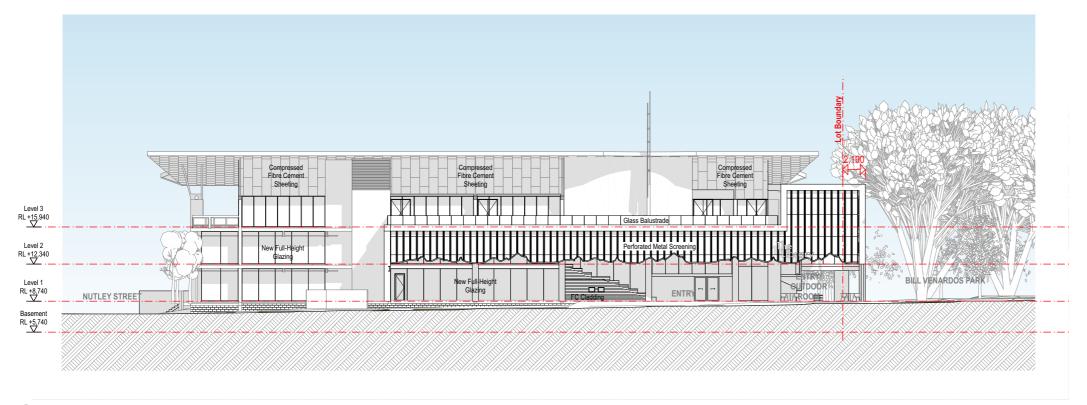
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01	Stage 2 Preliminary Design Stage 2 Preliminary Design	18/8/20	
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02 03 04 08	Stage 2 Preliminary Design Stage 2 Preliminary Design Stage 2 Preliminary Design Stage 2 Preliminary Design	19/8/20 20/8/20 26/8/20 31/8/20	
02 03 04 08	Stage 2 Preliminary Design Stage 2 Preliminary Design Stage 2 Parliming Design Stage 2 Preliminary Design Stage 3 Preliminary Design Stage 3 Preliminary Design Description	19/8/20 20/8/20 26/8/20 31/8/20	
02 03 04 08 A Rev Arch	Stage 2 Preliminary Design Stage 2 Preliminary Design Stage 2 Preliminary Design Stage 2 Preliminary Design Stage 3 Preliminary Design Stage 4 Descripton Stage 4 Descripton	19/8/20 20/8/20 26/8/20 31/8/20 23/2/21 23/2/21 Date	CtS 1 2755 2 1129
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02 03 04 06 A Rev Arch B B W W		19820 20820 28720 31920 23/221 23/221 Date Date T 07 363 F 07 363 F 07 363 F 07 363 F 07 363 S N 11 009 S	Cts 12755 21129 60 838 39
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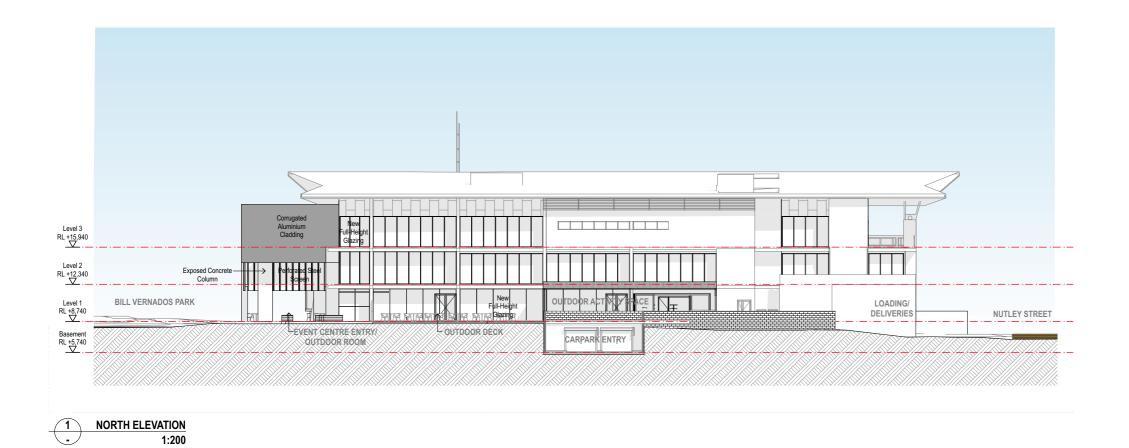
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	igured dimensions take precedence over so	aled.
	igured dimensions are millimetres unless n	oted otherwise.
4. Tł	heck all dimensions on site prior to comme hese designs, drawings and specifications,	and copyright thereof, are
th	e property of Blair M Wilson and Associate rchitects, and must not be used, retained o	s Pty. Ltd. trading as Wilso
a	uthority of Wilson Architects.	copied without the written
BASE	EMENT CARPARK AREA SCHEDULE	AREA m2
Circul	lation	AREA IIIZ
	BASEMENT CARPARK 36 PARKS FOYER	1,248
	Fire Stair	11
Plant		1,279 m²
Fidili	PLANT ROOM	91
	RAINWATER TANK SWB RISER	39 5
	SWB KISEK	135 m ²
Stora		00
	KIOSK STORE/COLD ROOM LOCKERS/ BIKE PARKING	39 25
		64 m ²
		1,478 m ²
	PARKING SCHEDULE	
	STANDARD BAYS TANDEM BAYS	25 8 2
	STANDARD BAYS	
01	STANDARD BAYS TANDEM BAYS PWD BAYS KIOSK SERVICE BAY TOTAL	8 2 1 36 3/8/20
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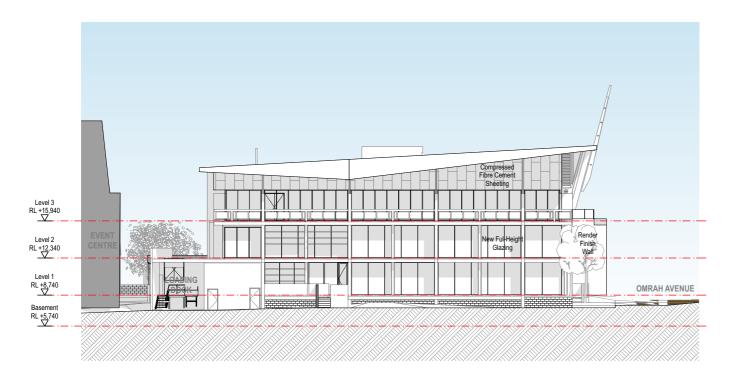


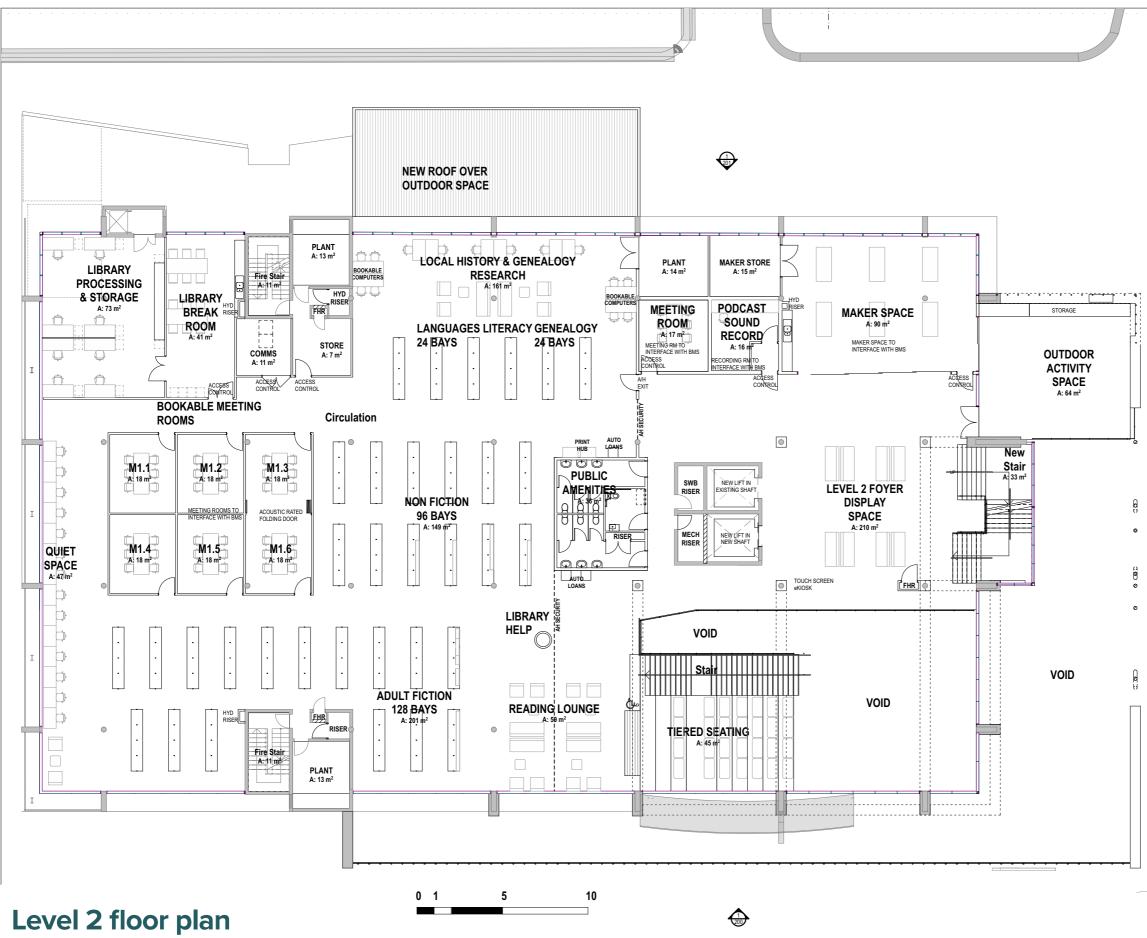SOUTH ELEVATION - 1:200




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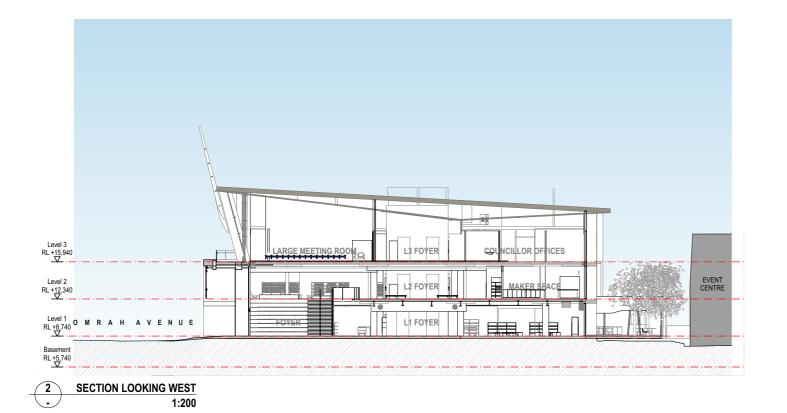


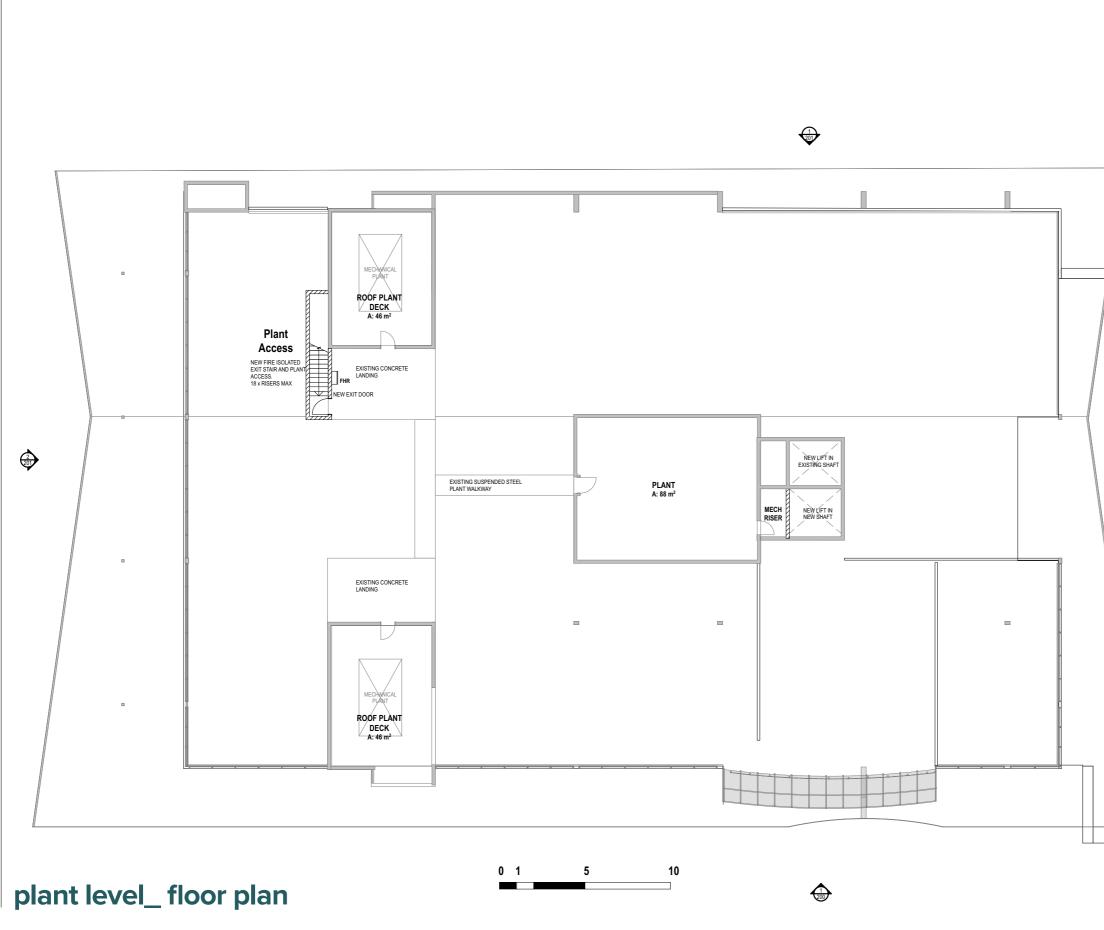

2 WEST ELEVATION - 1:200

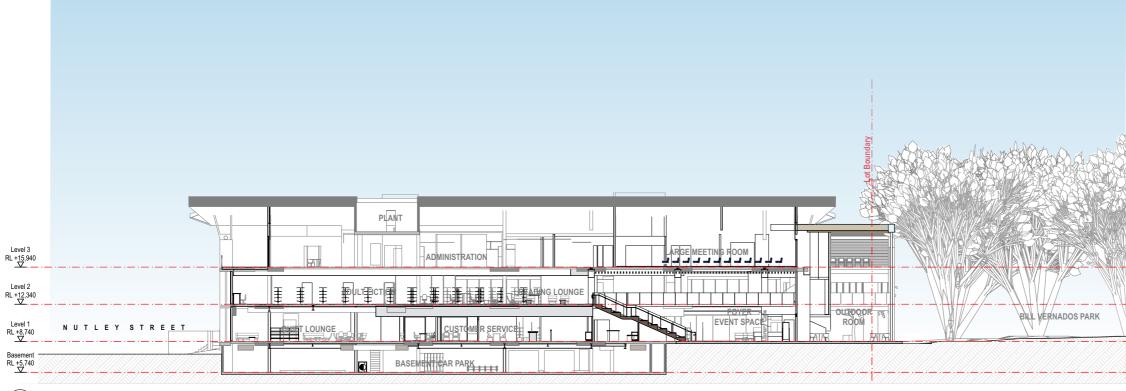

LONG SECTION LOOKING NORTH . 1:200












appendix 1 - structural drawings







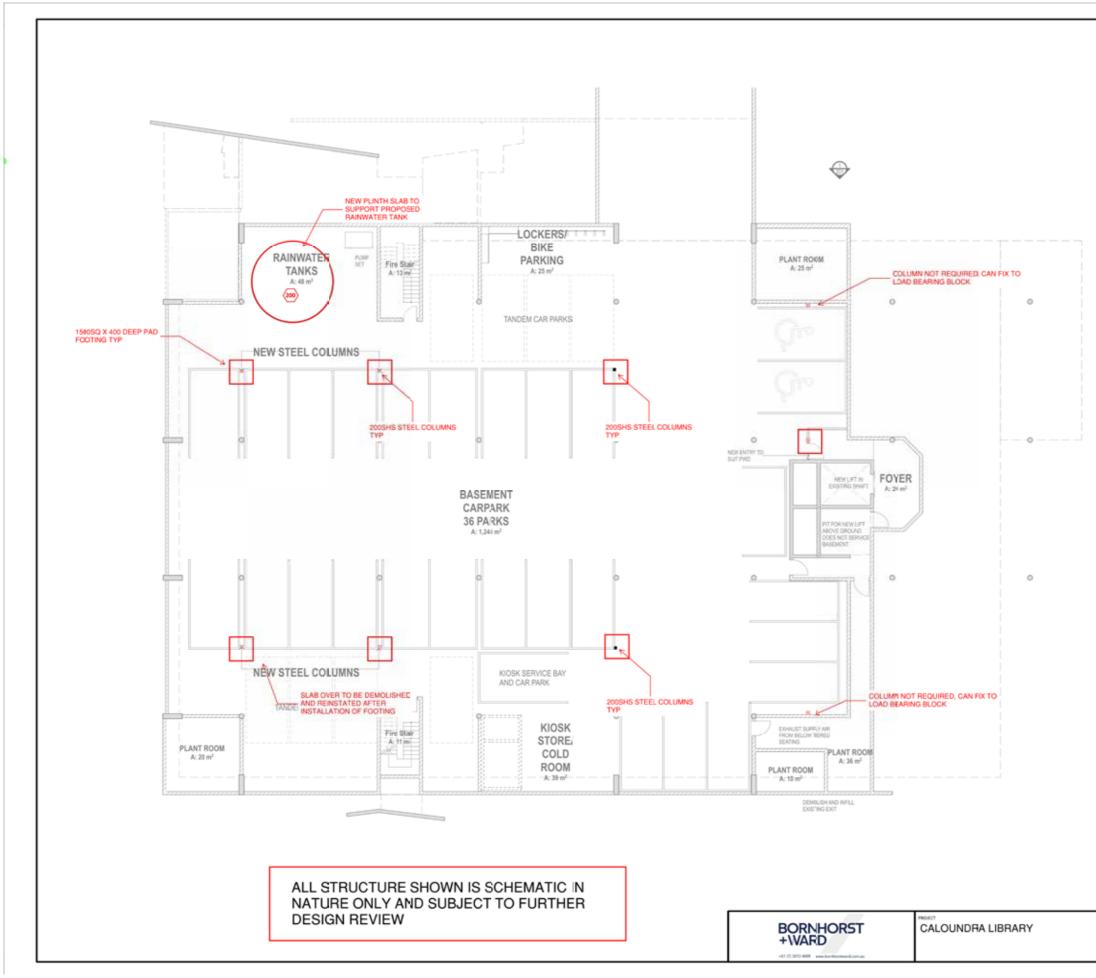


BASEMENT LEVEL	PROJECT No. 19087
	SK200817.1 2
0 10 20 30 40 5	ORIGINAL SIZE A1



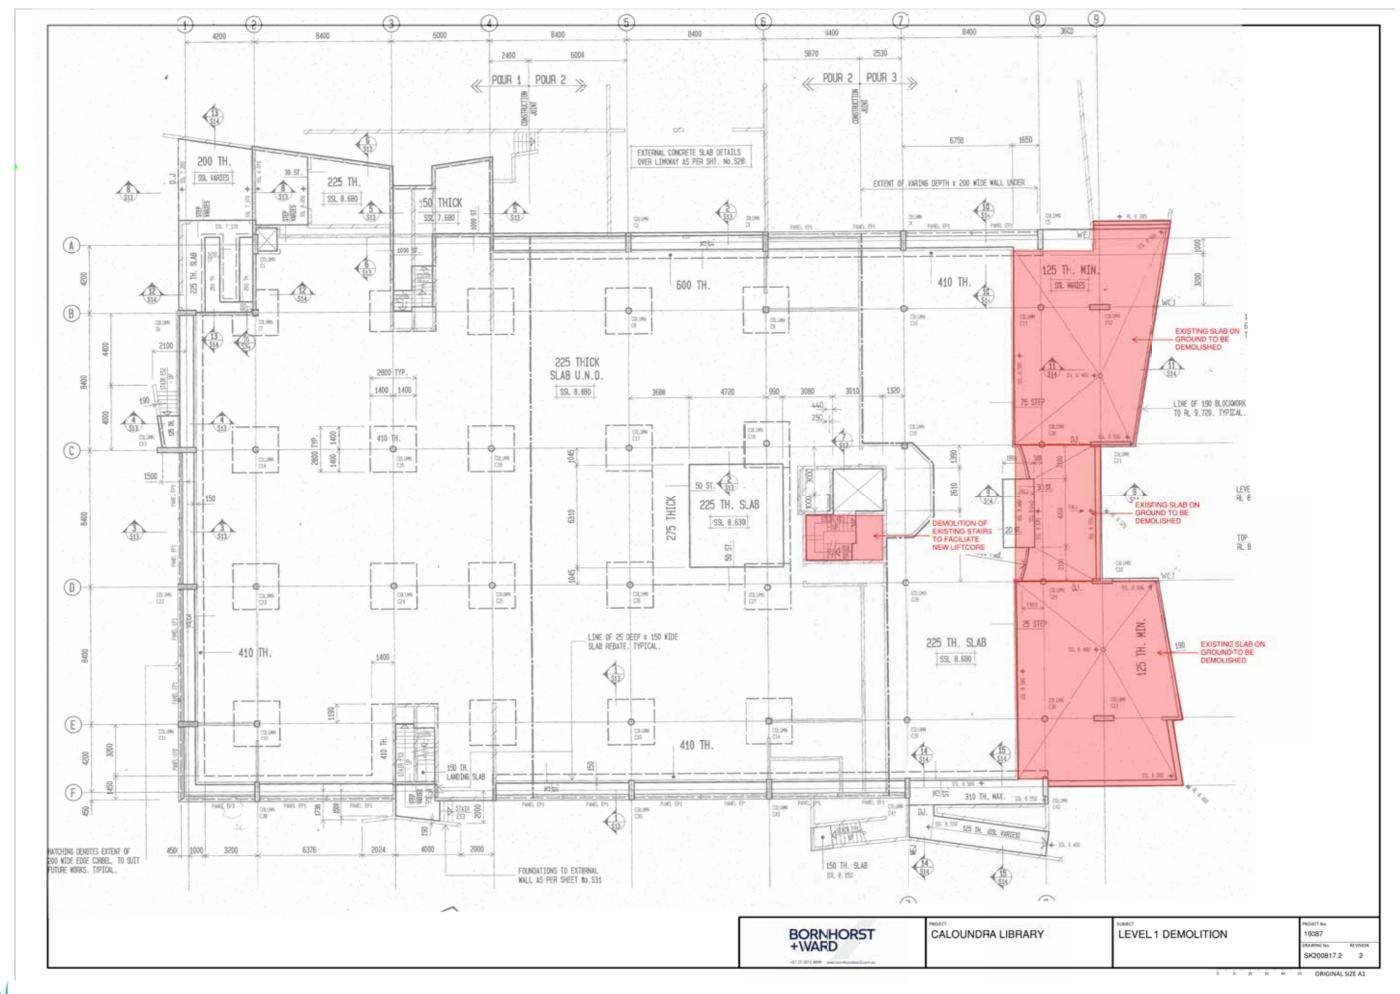

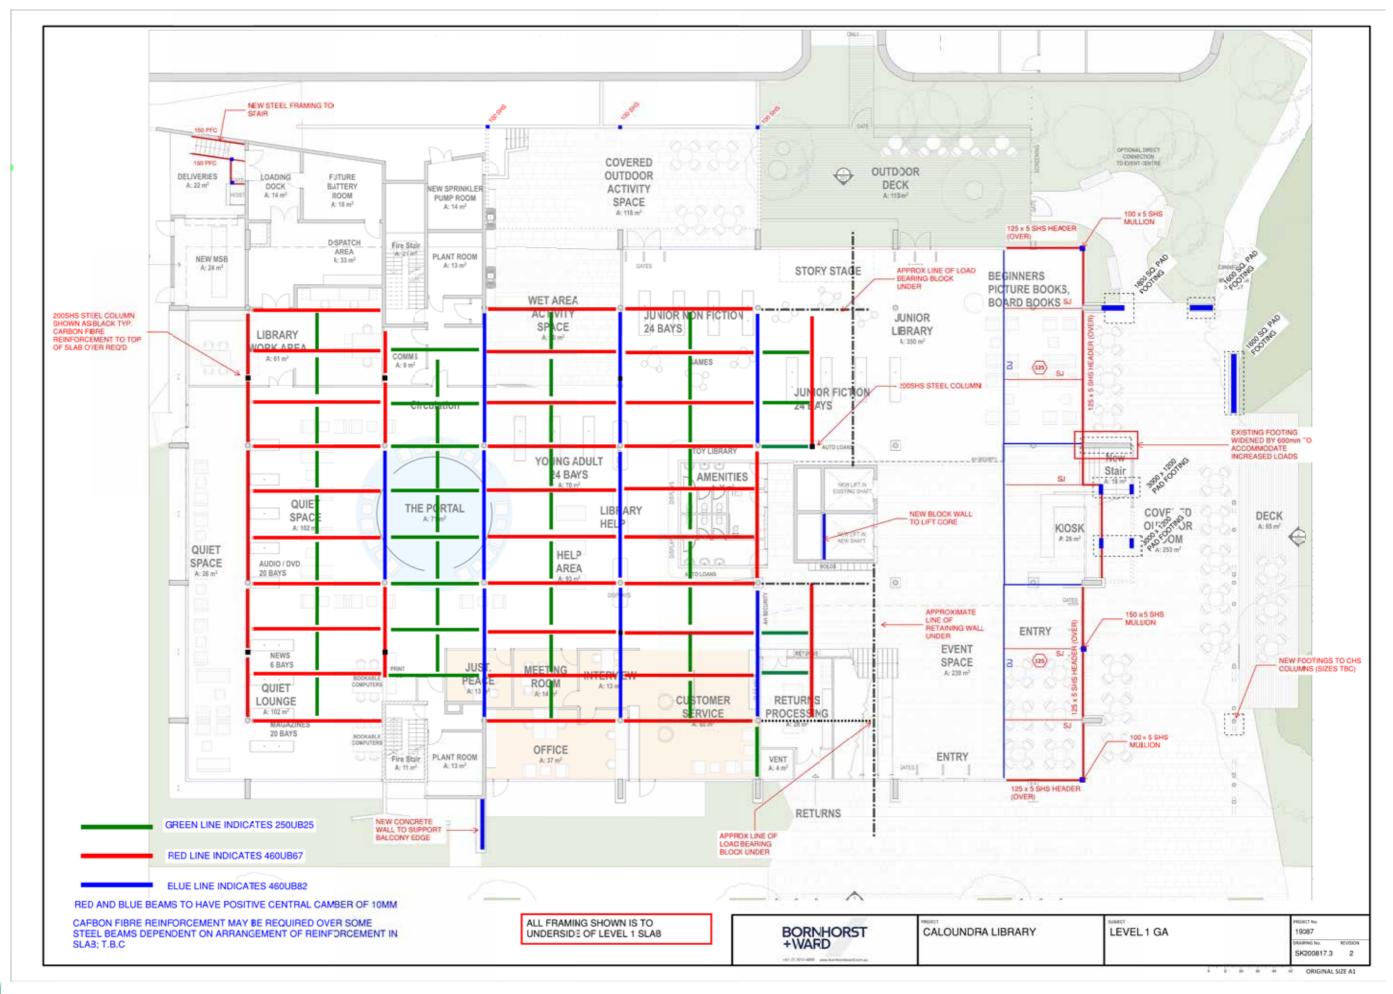


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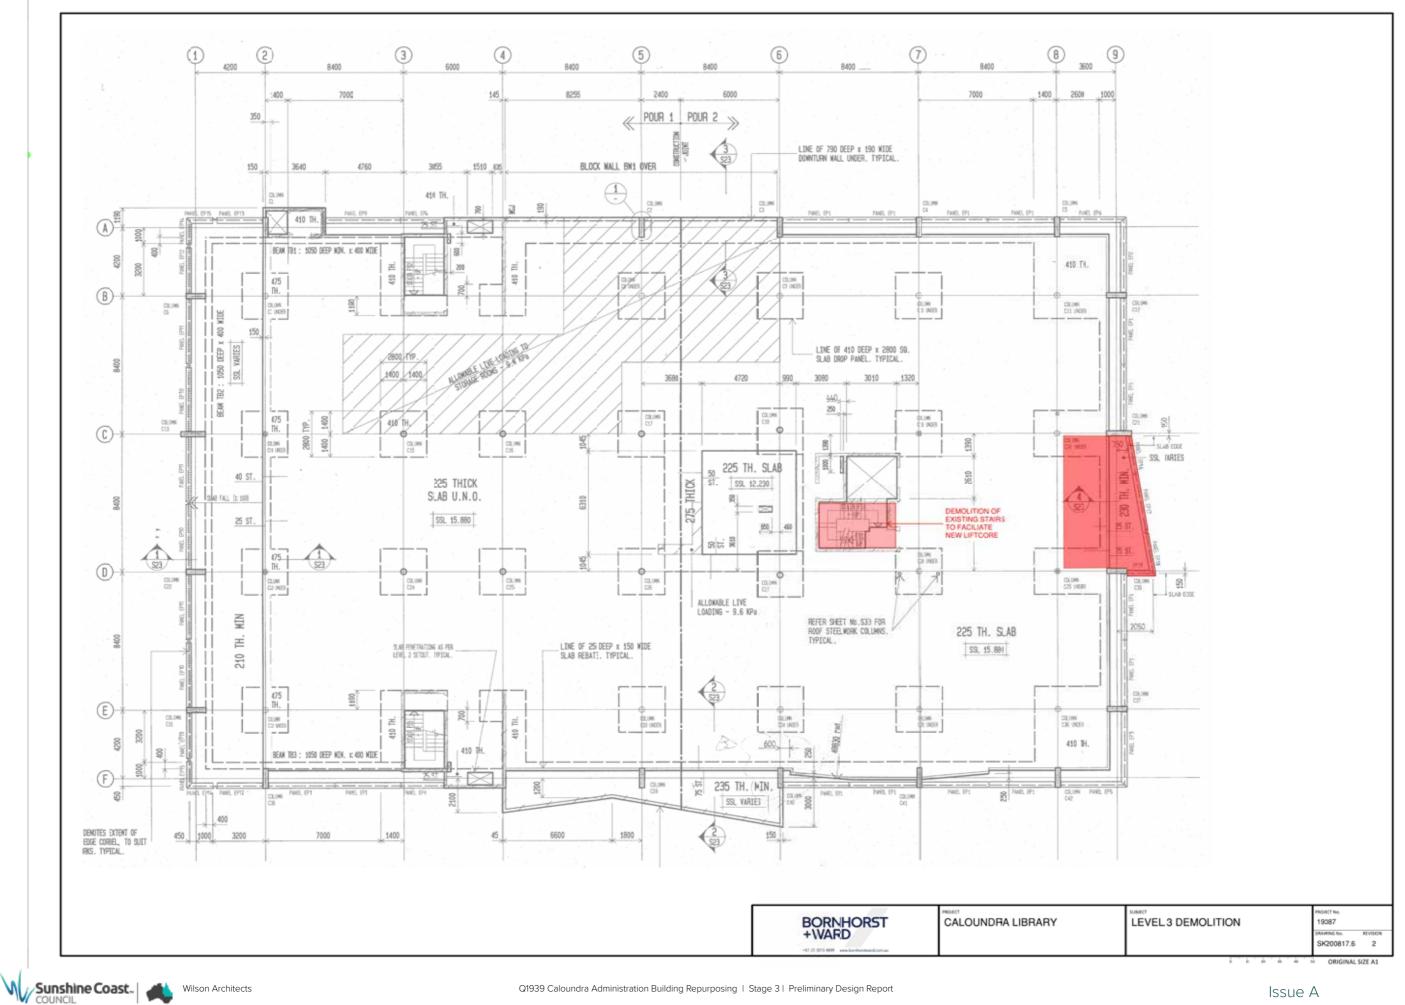

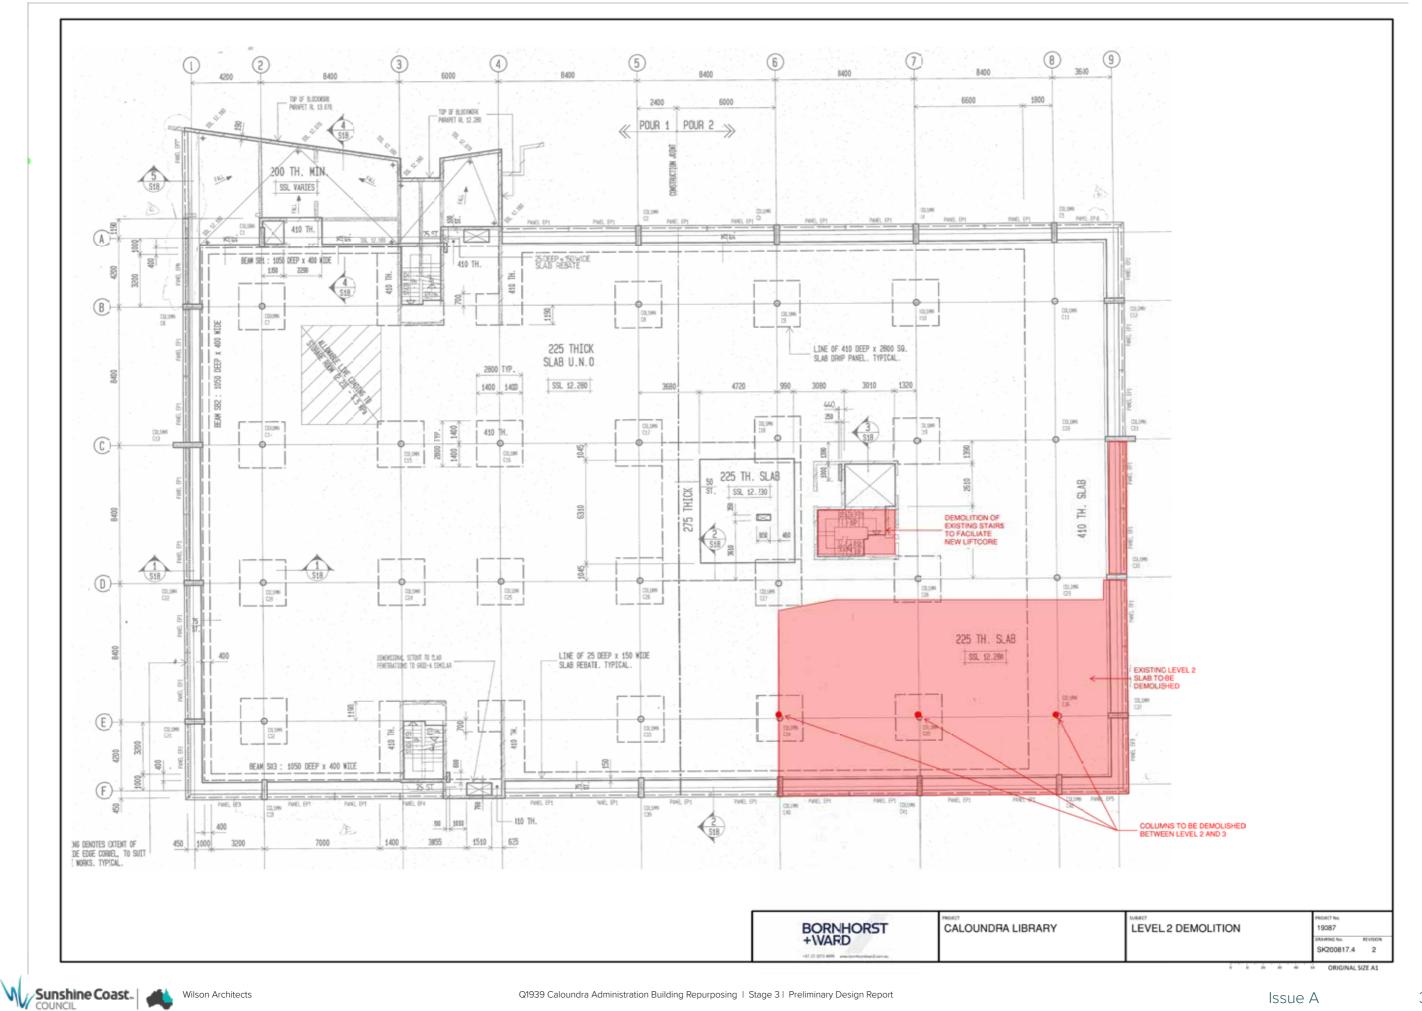
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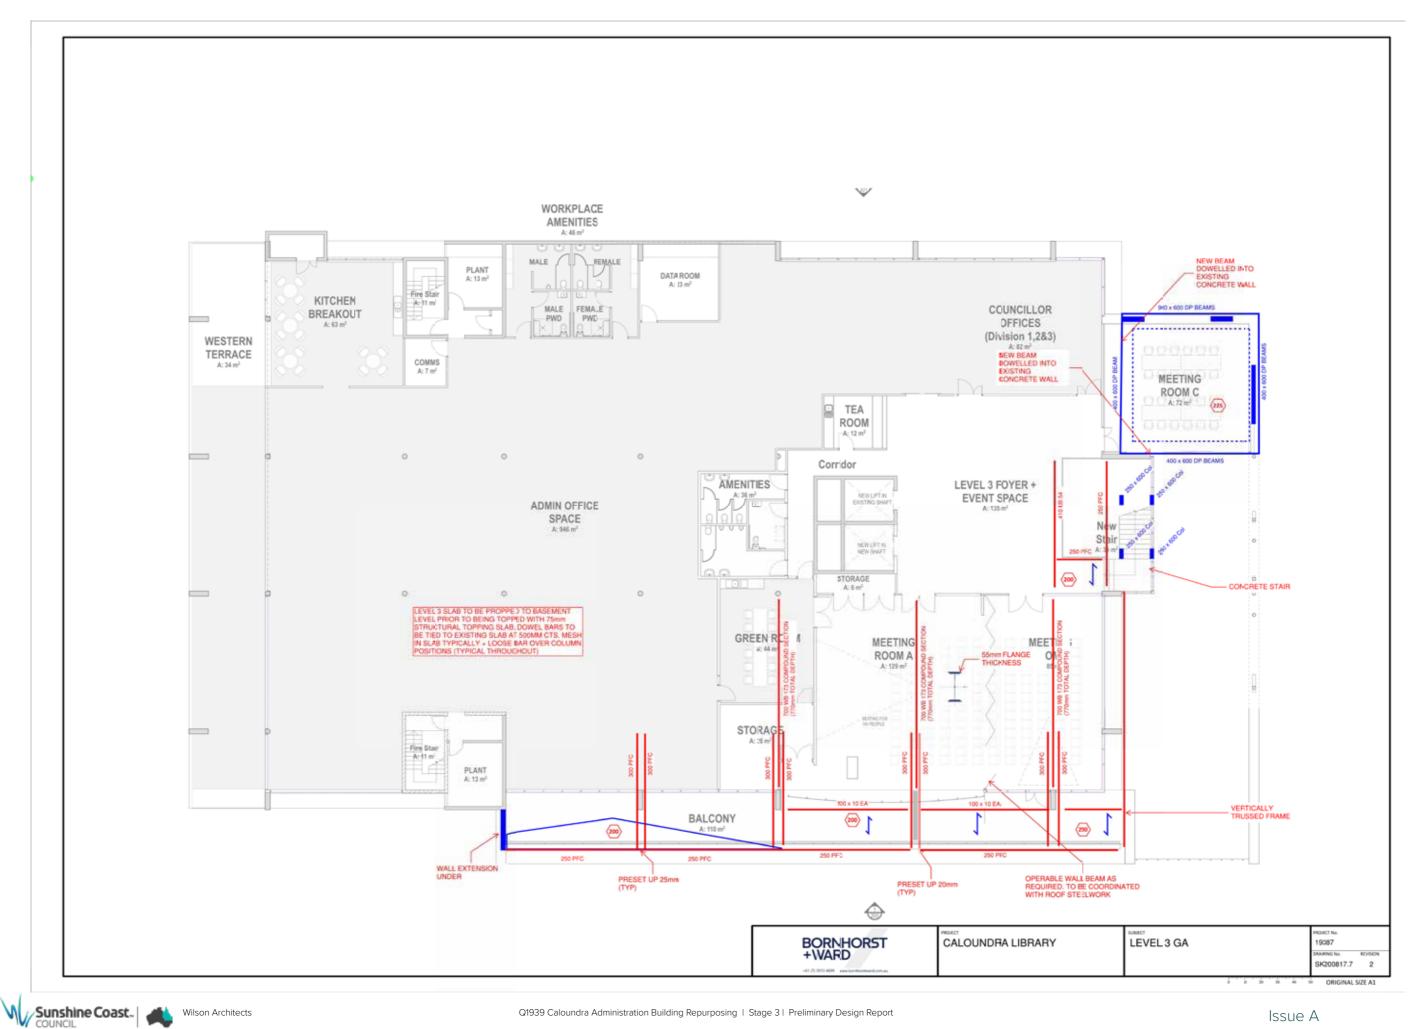







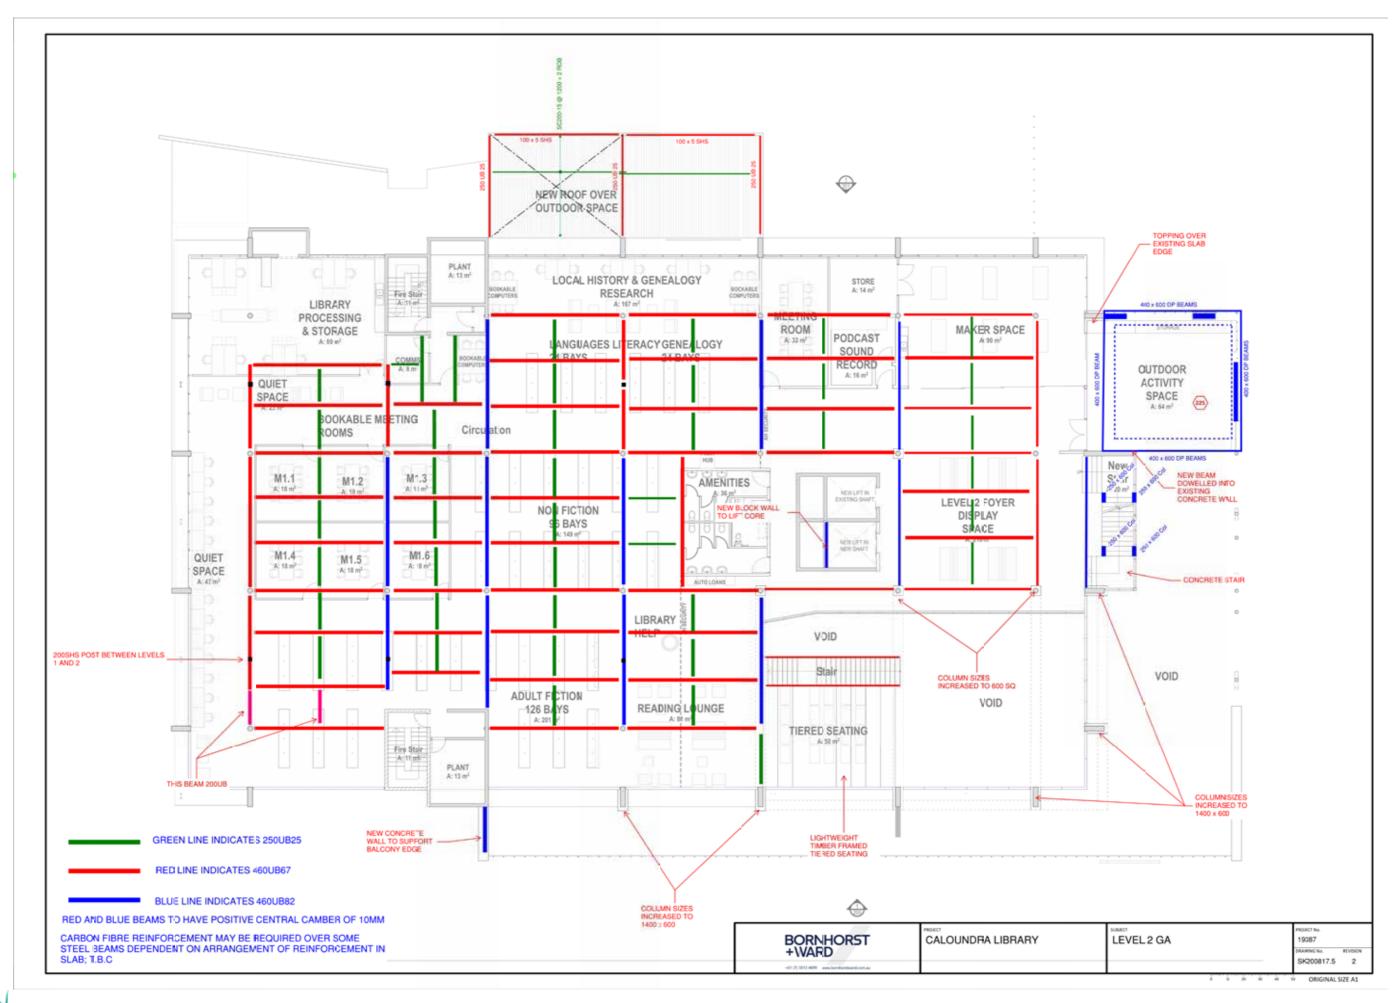

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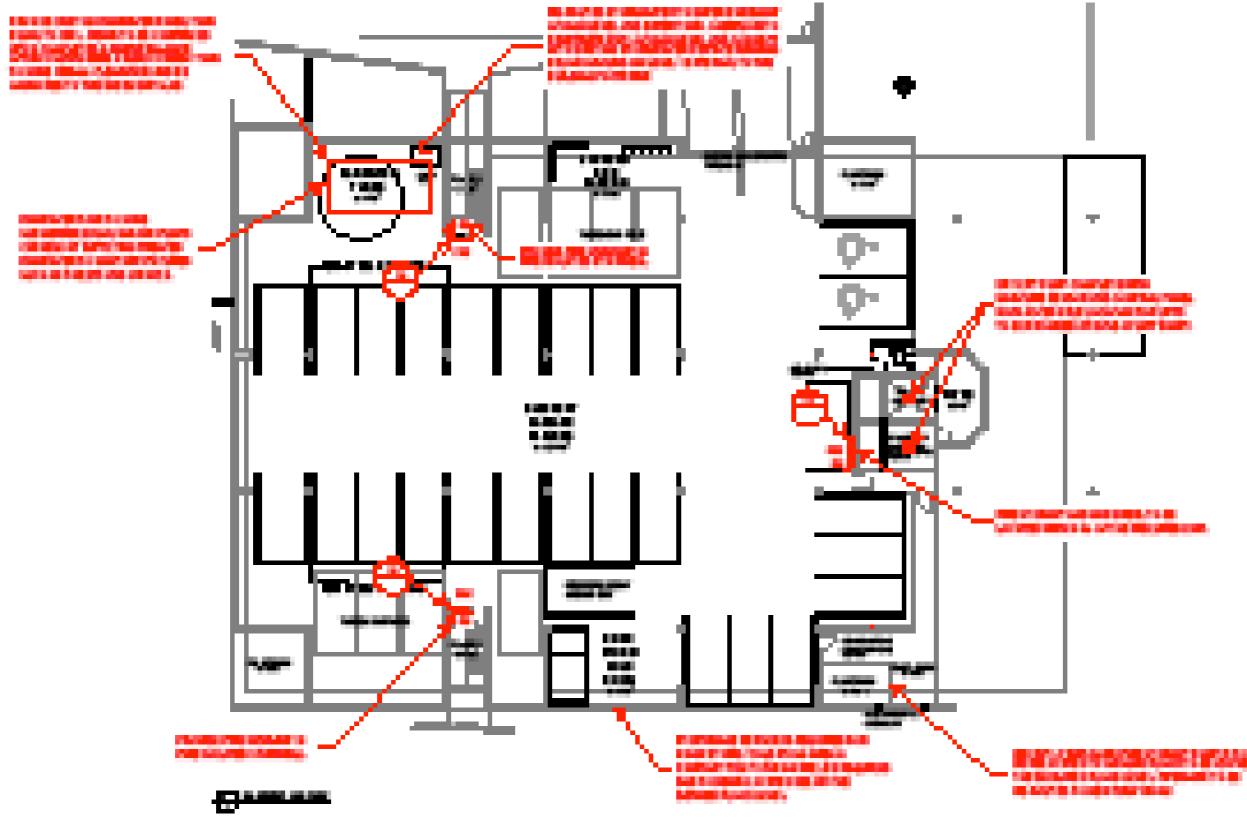




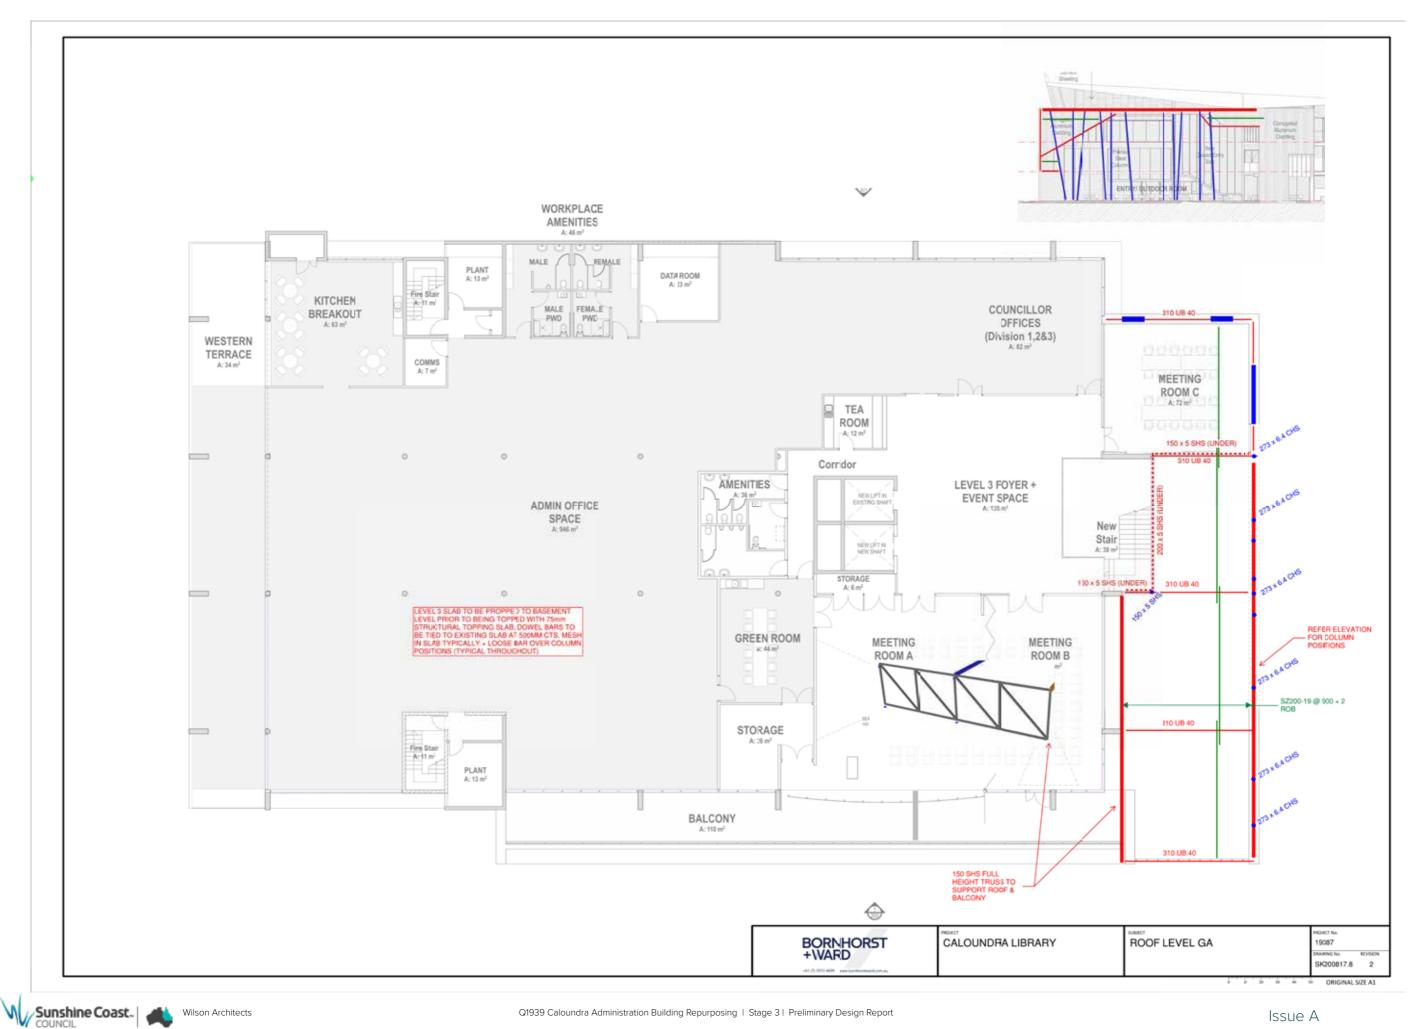


appendix 2 - hydraulic drawings












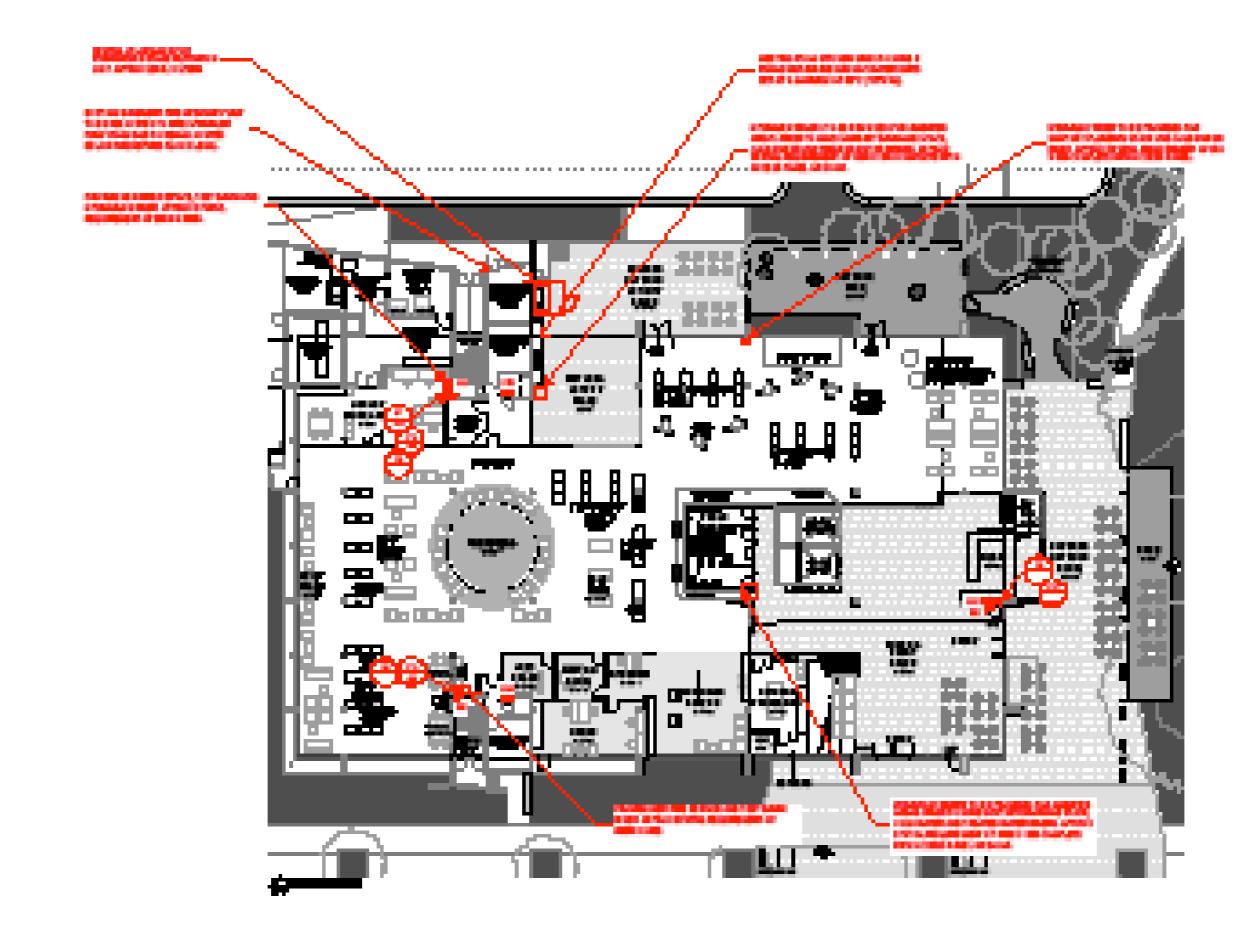

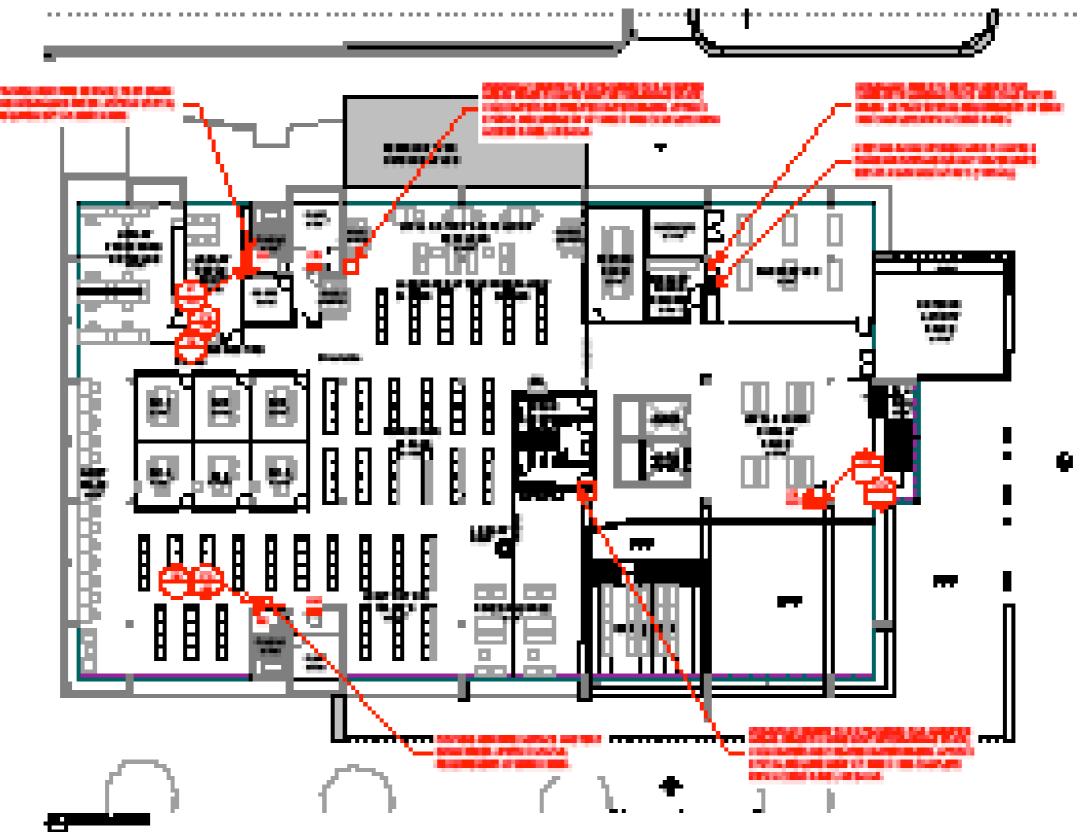

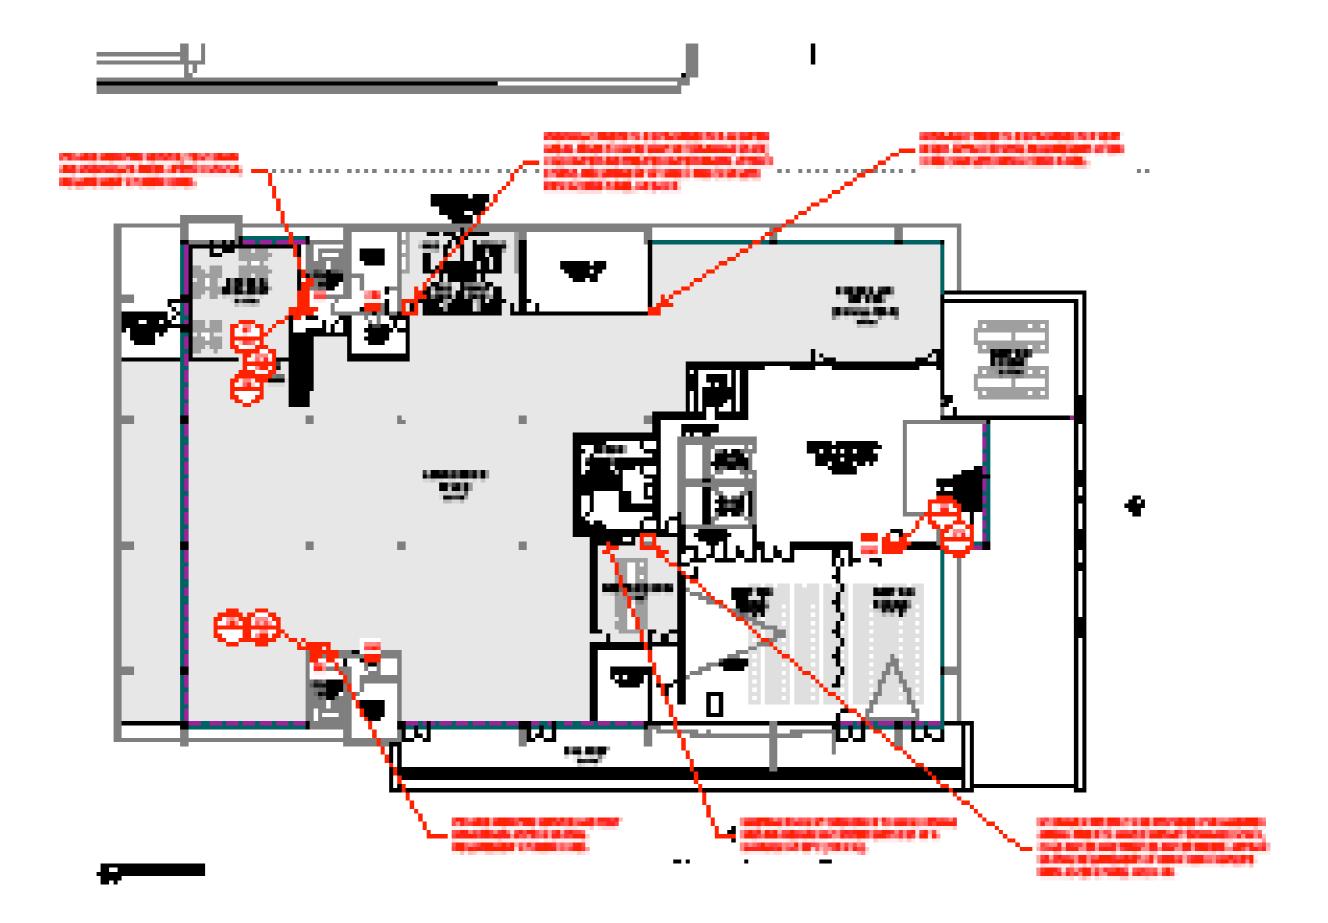

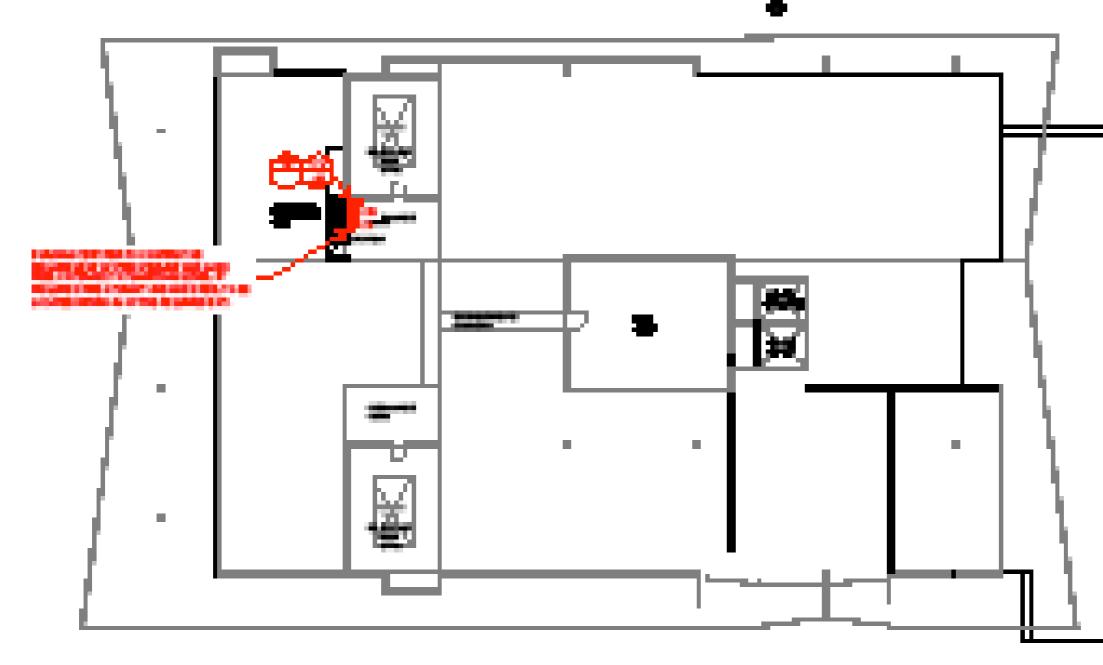




appendix 3 - ESD service drawings







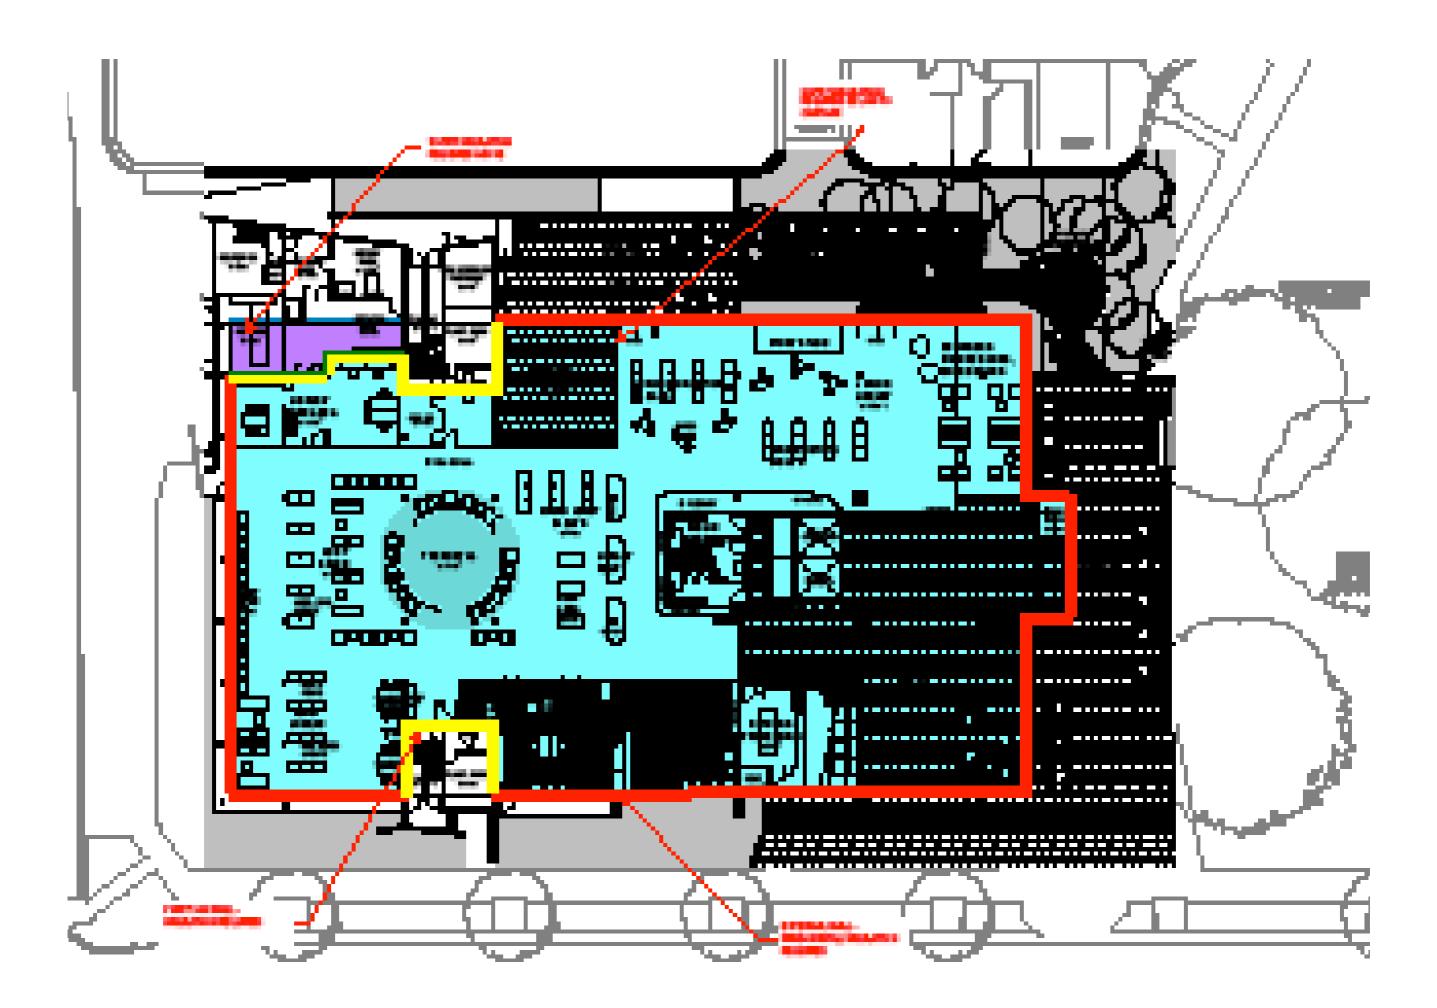

Issue A

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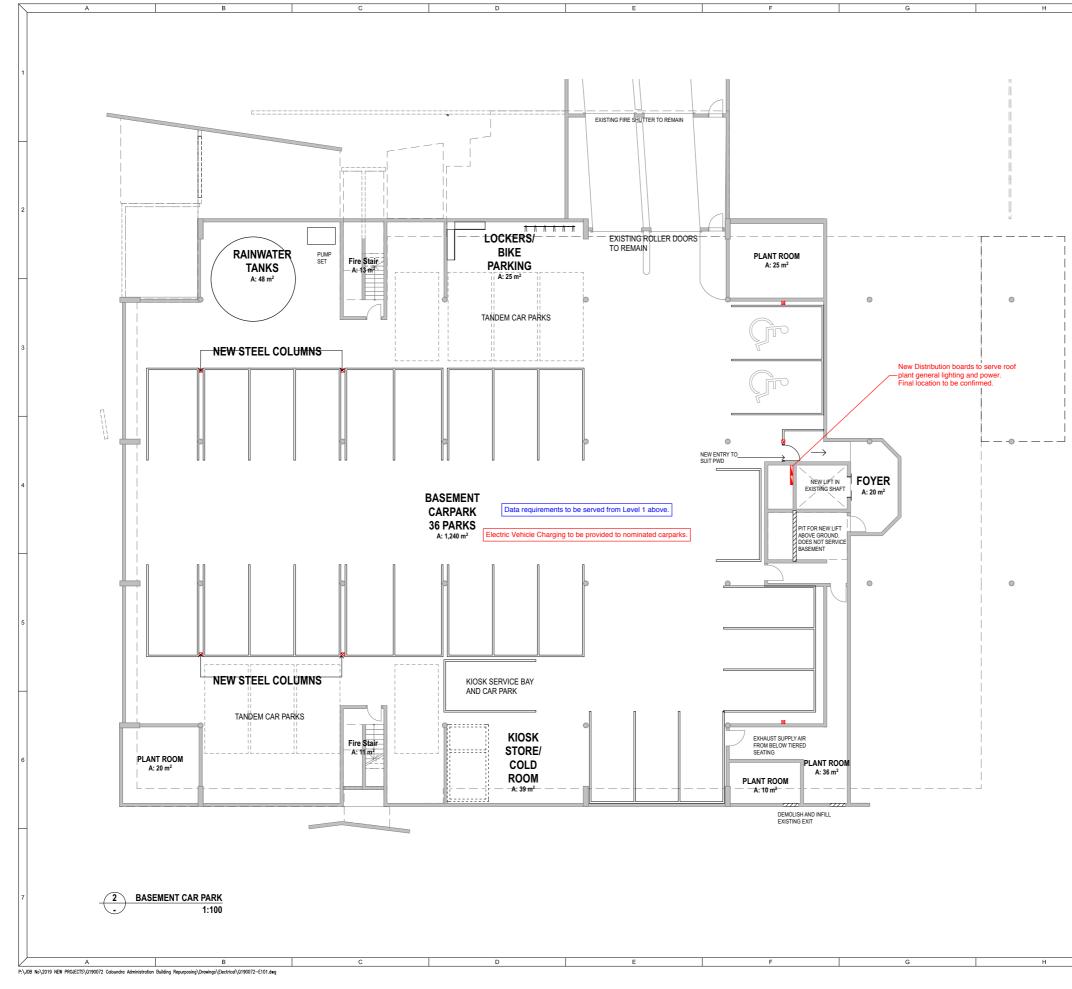


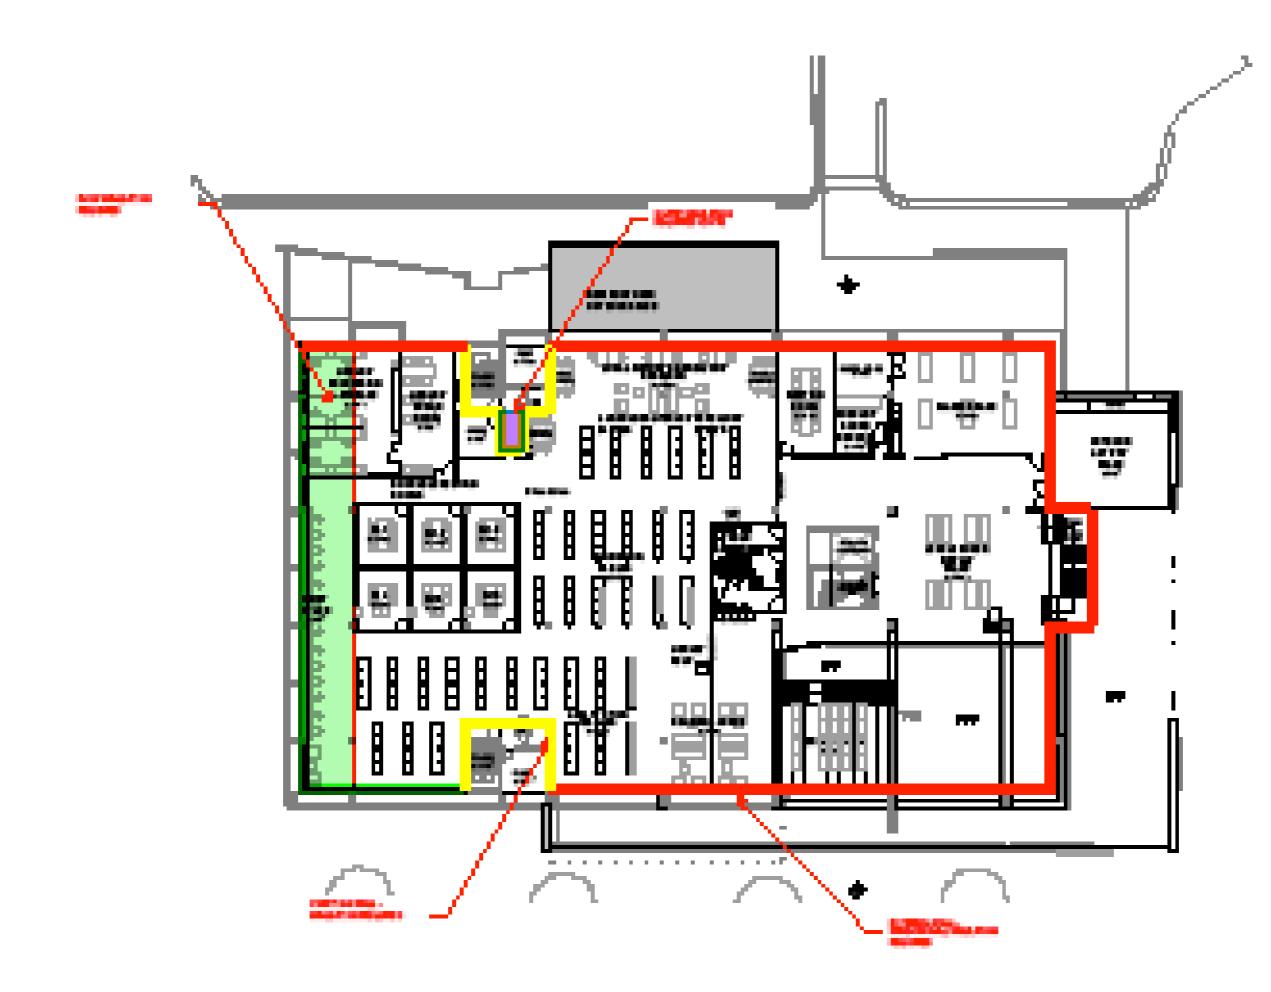


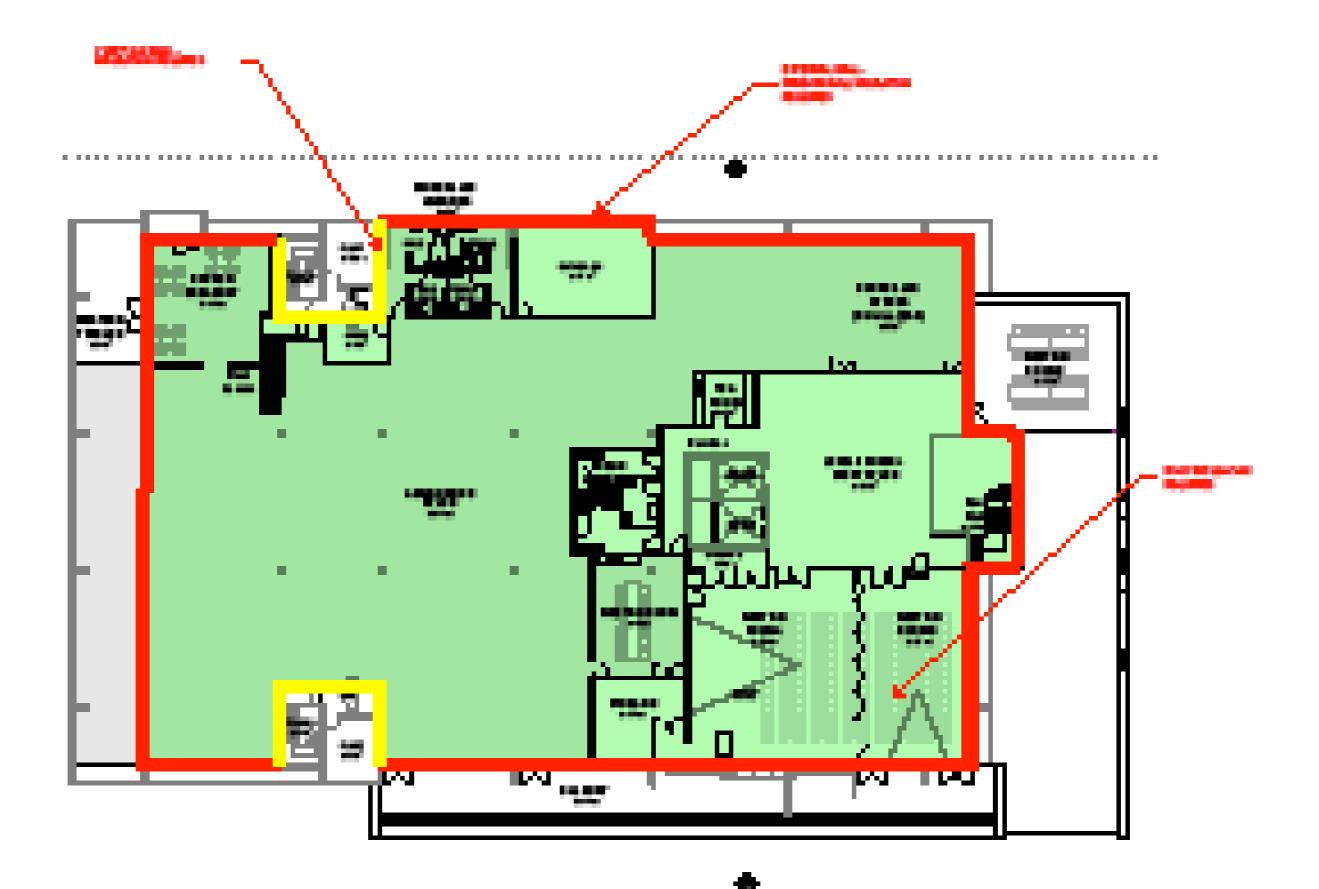
appendix 4 - electrical drawings









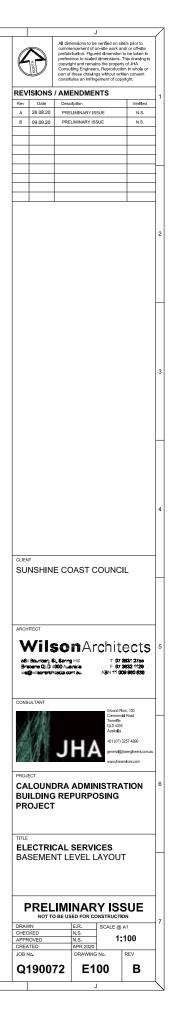


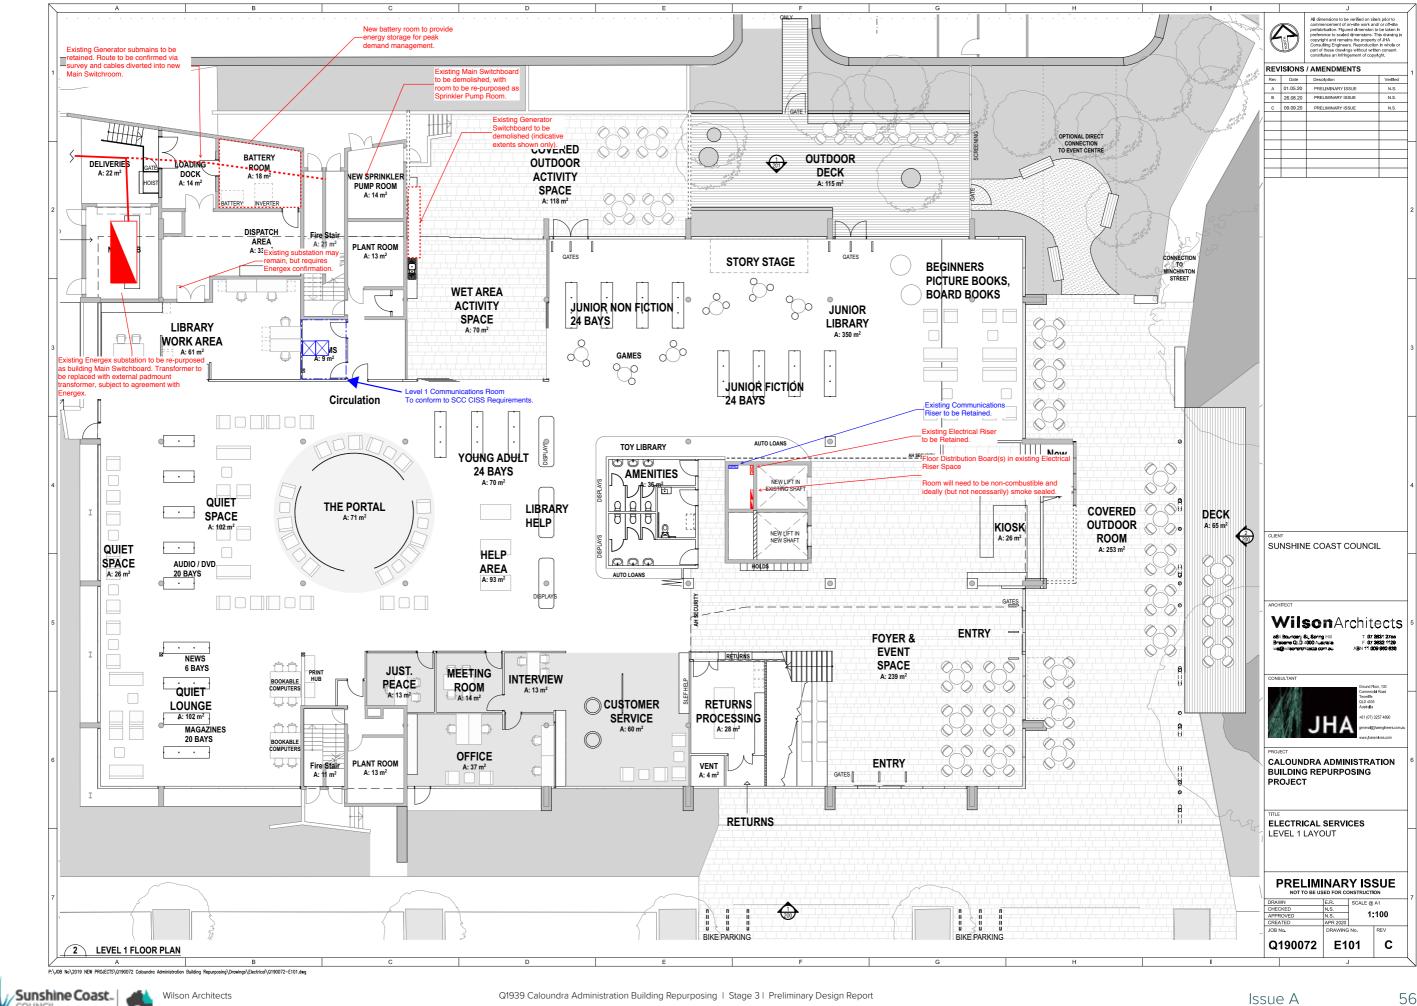

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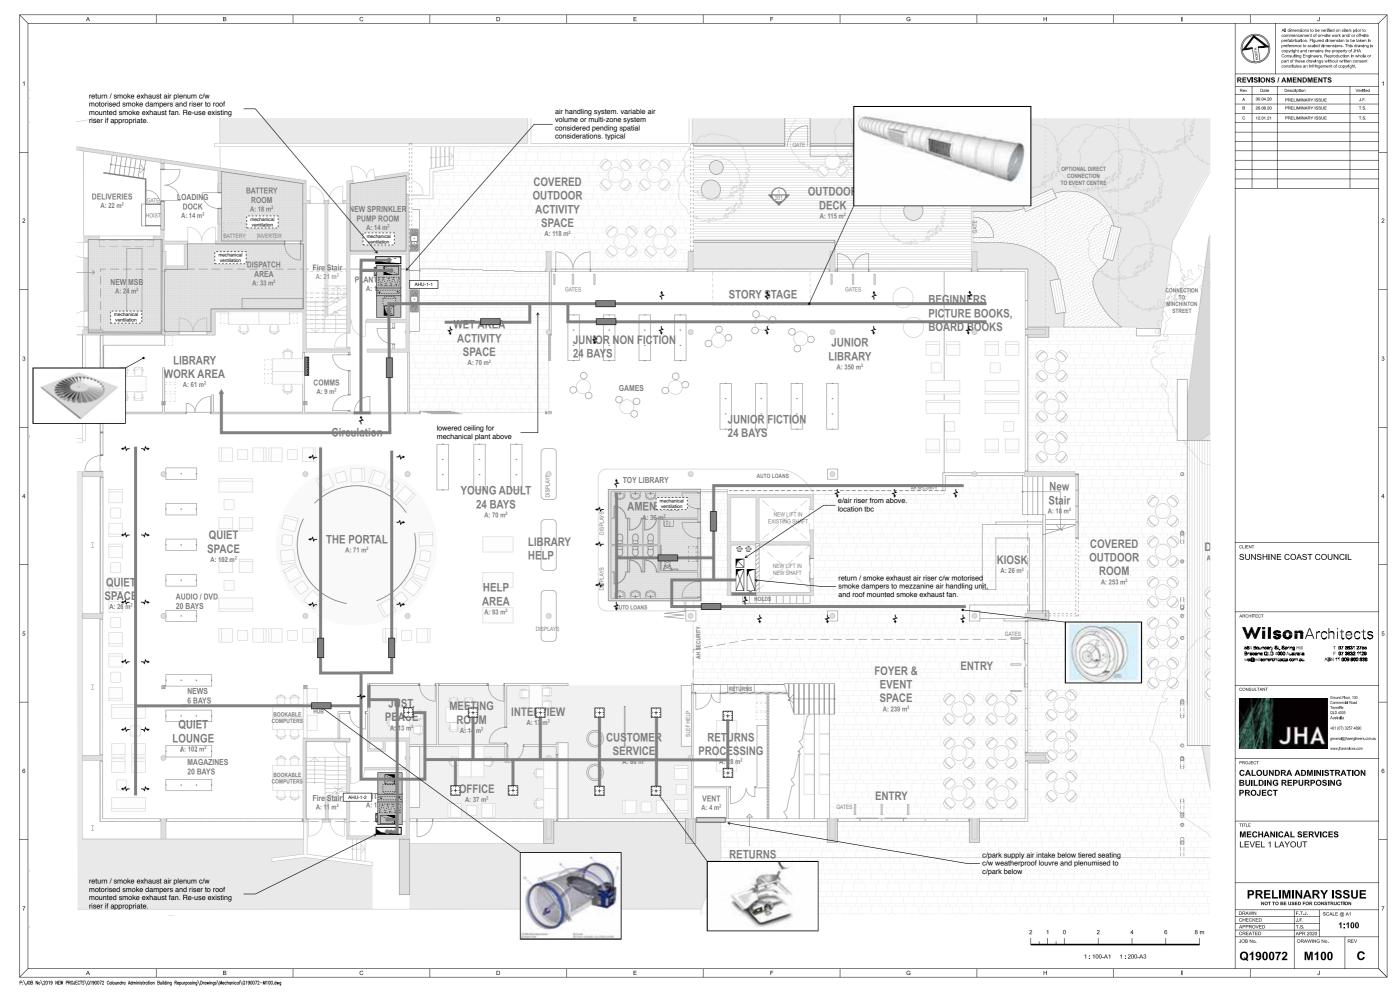


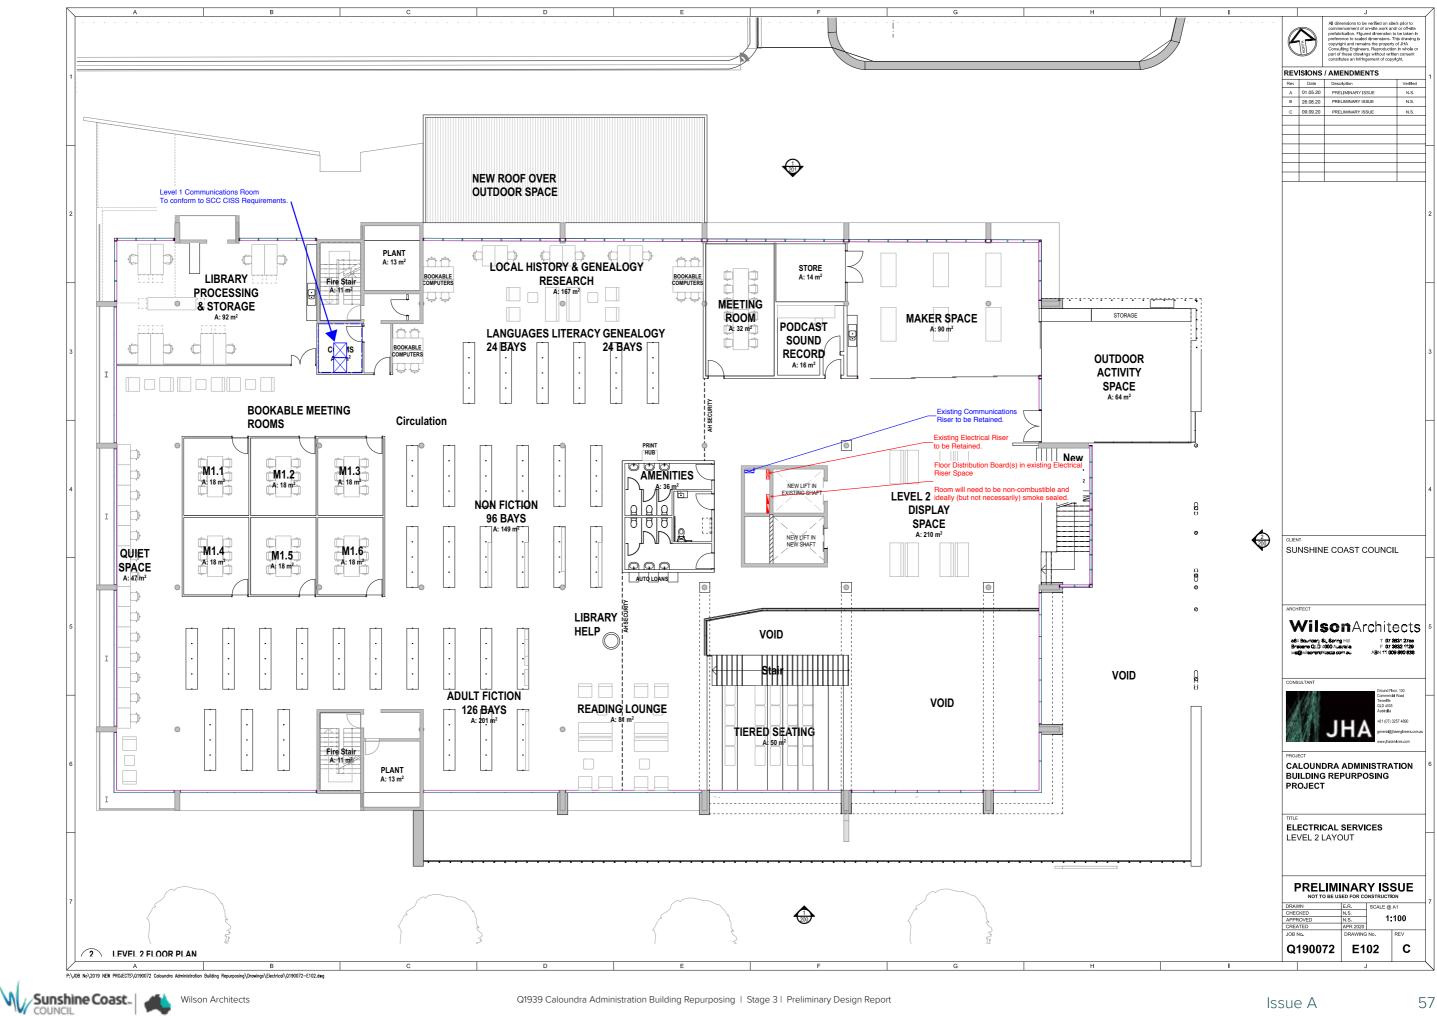appendix 5 - mechanical drawings

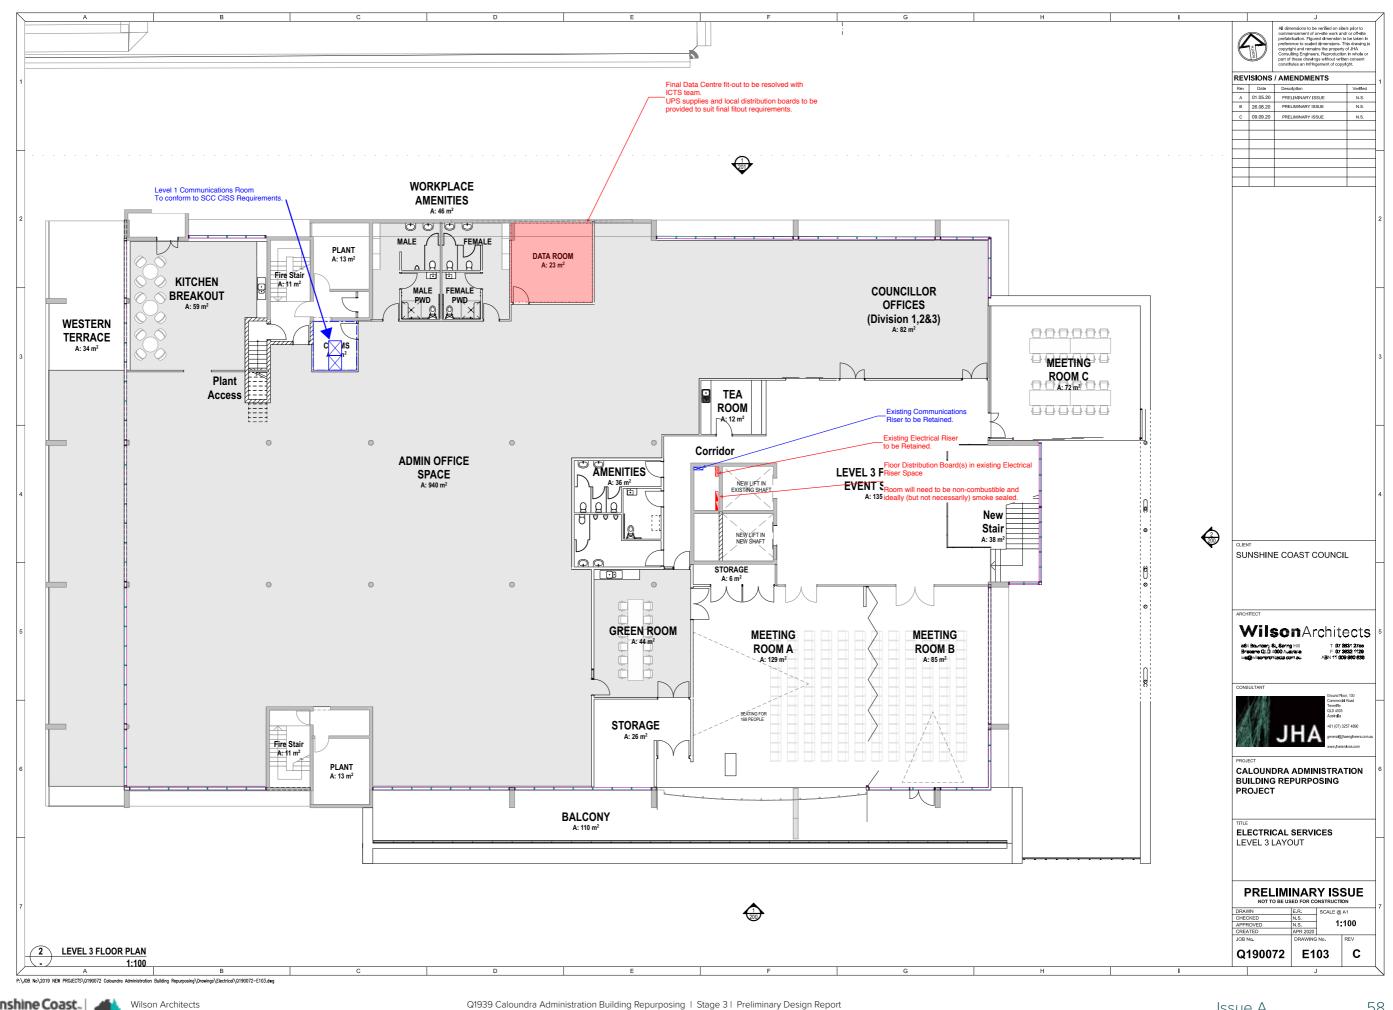


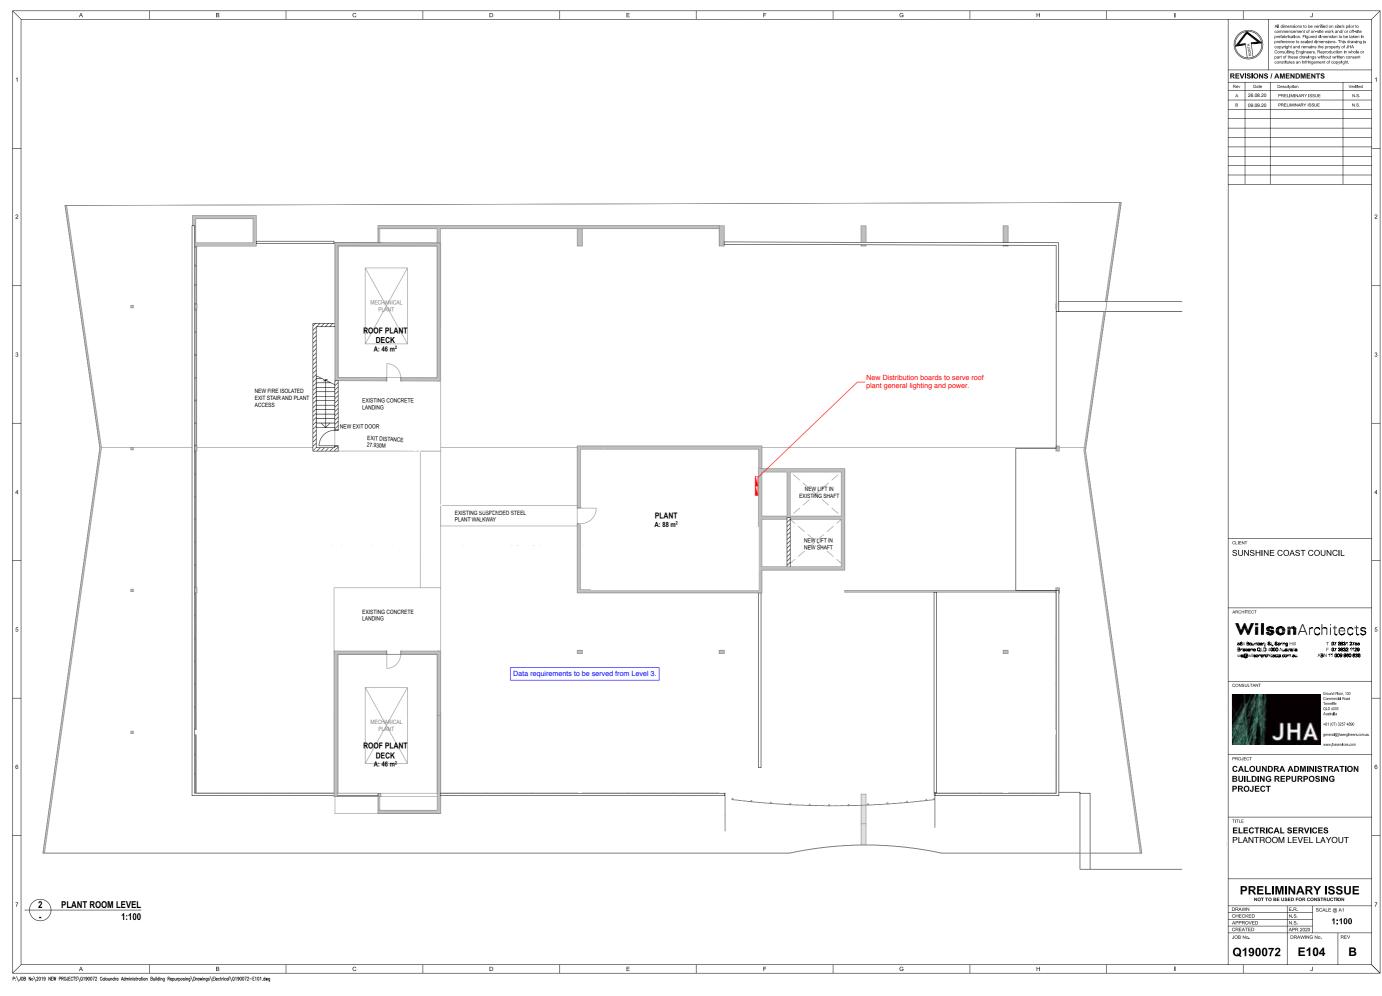









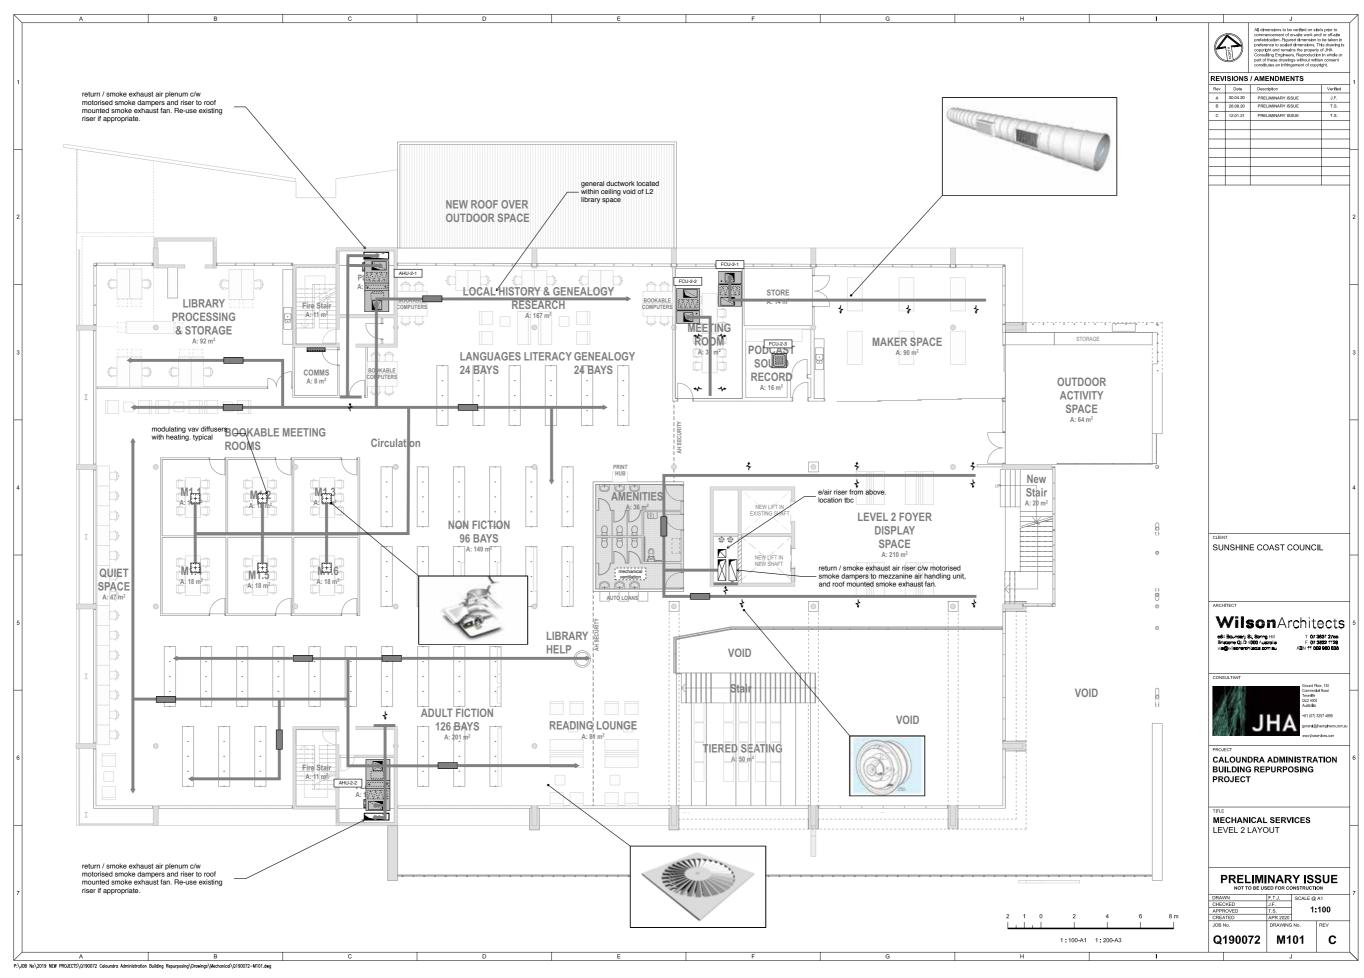




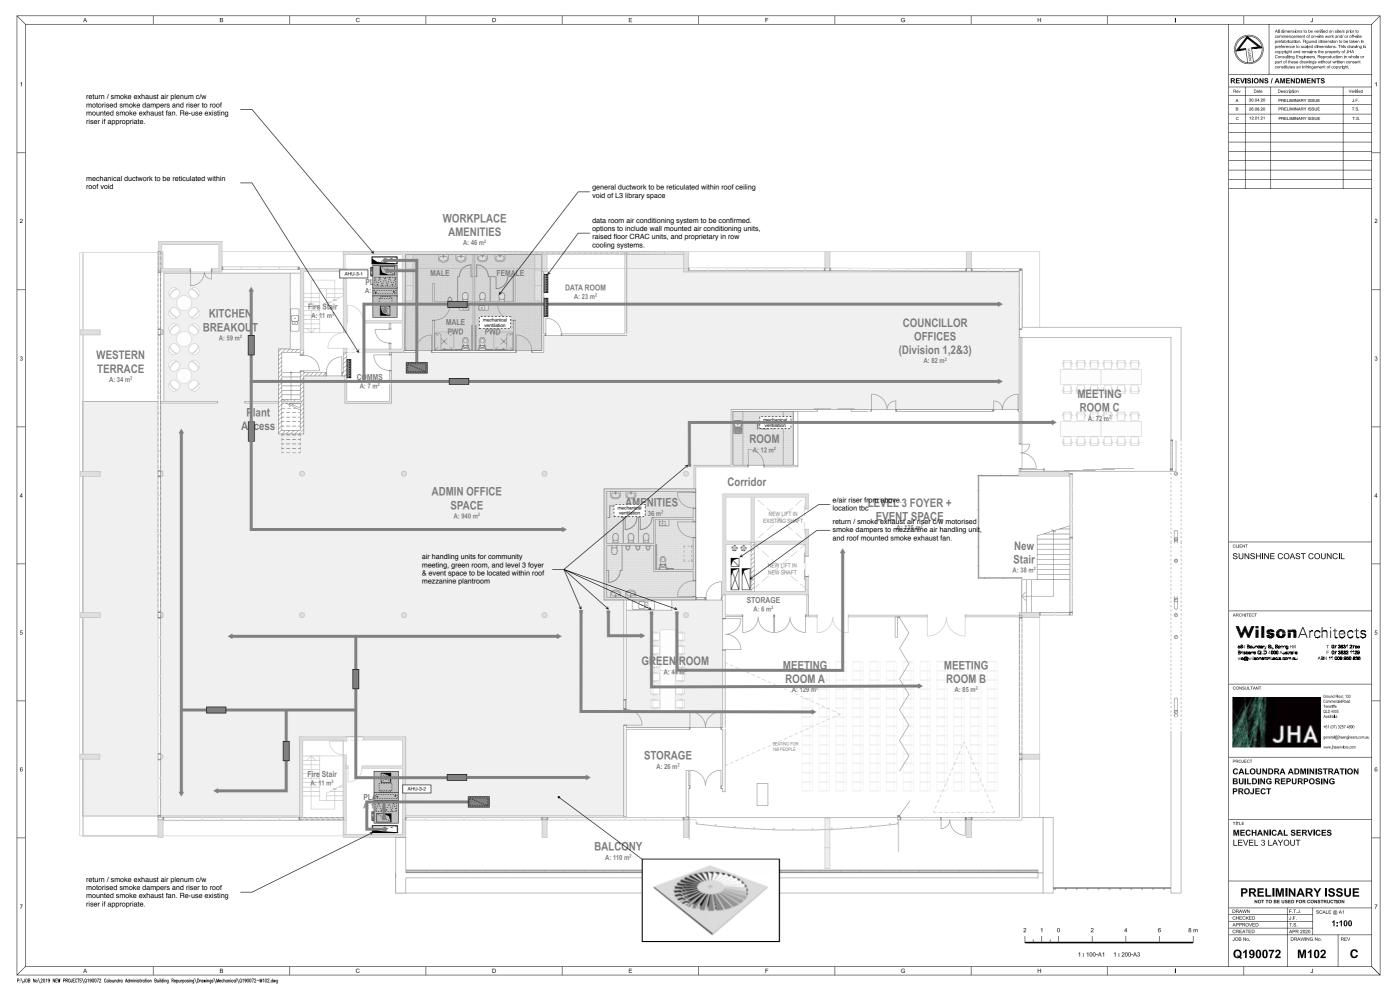





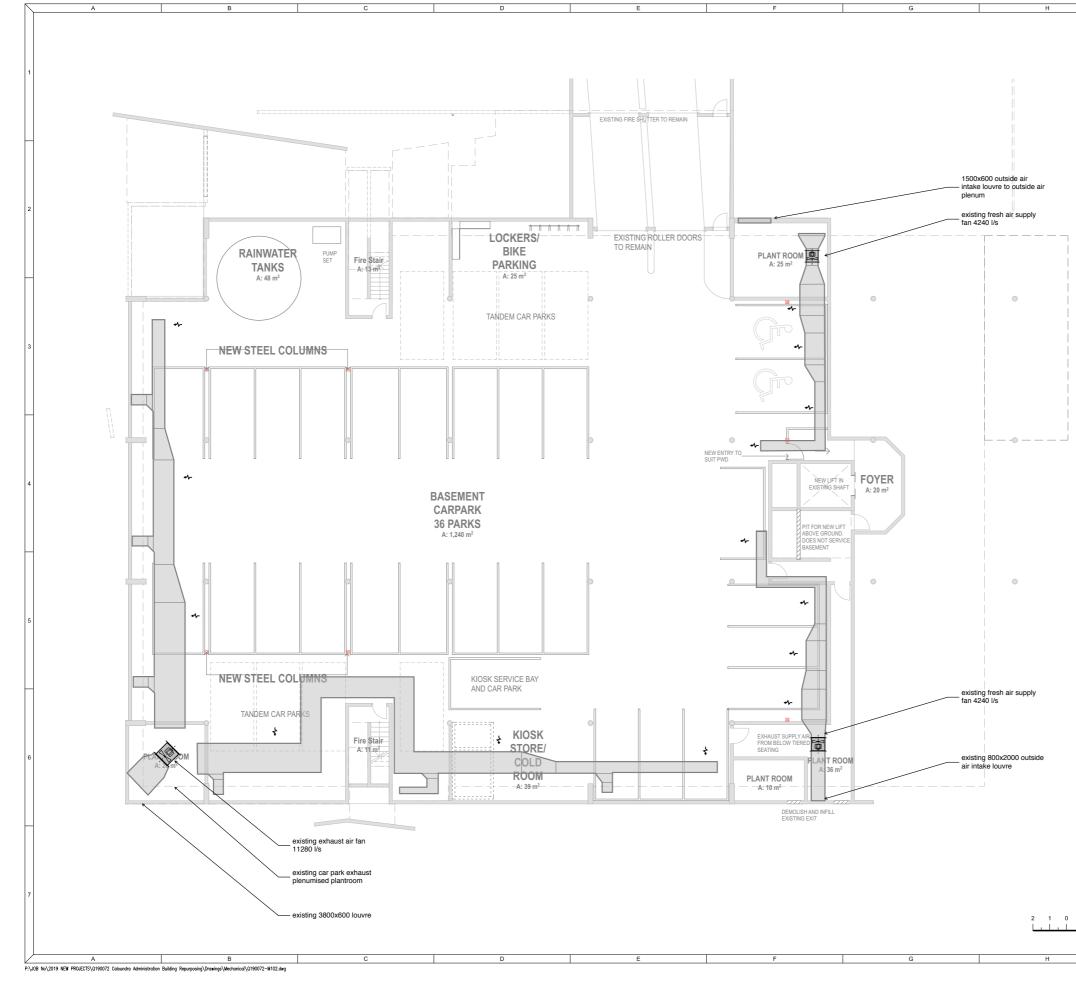



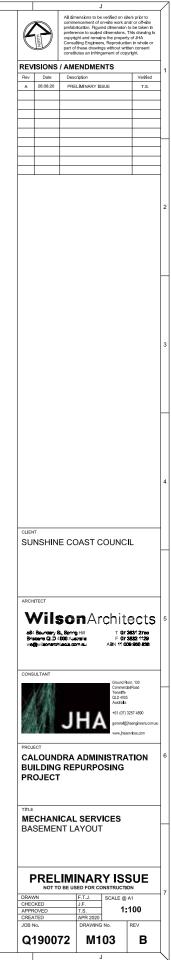

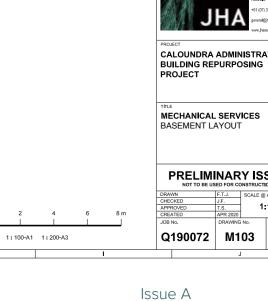

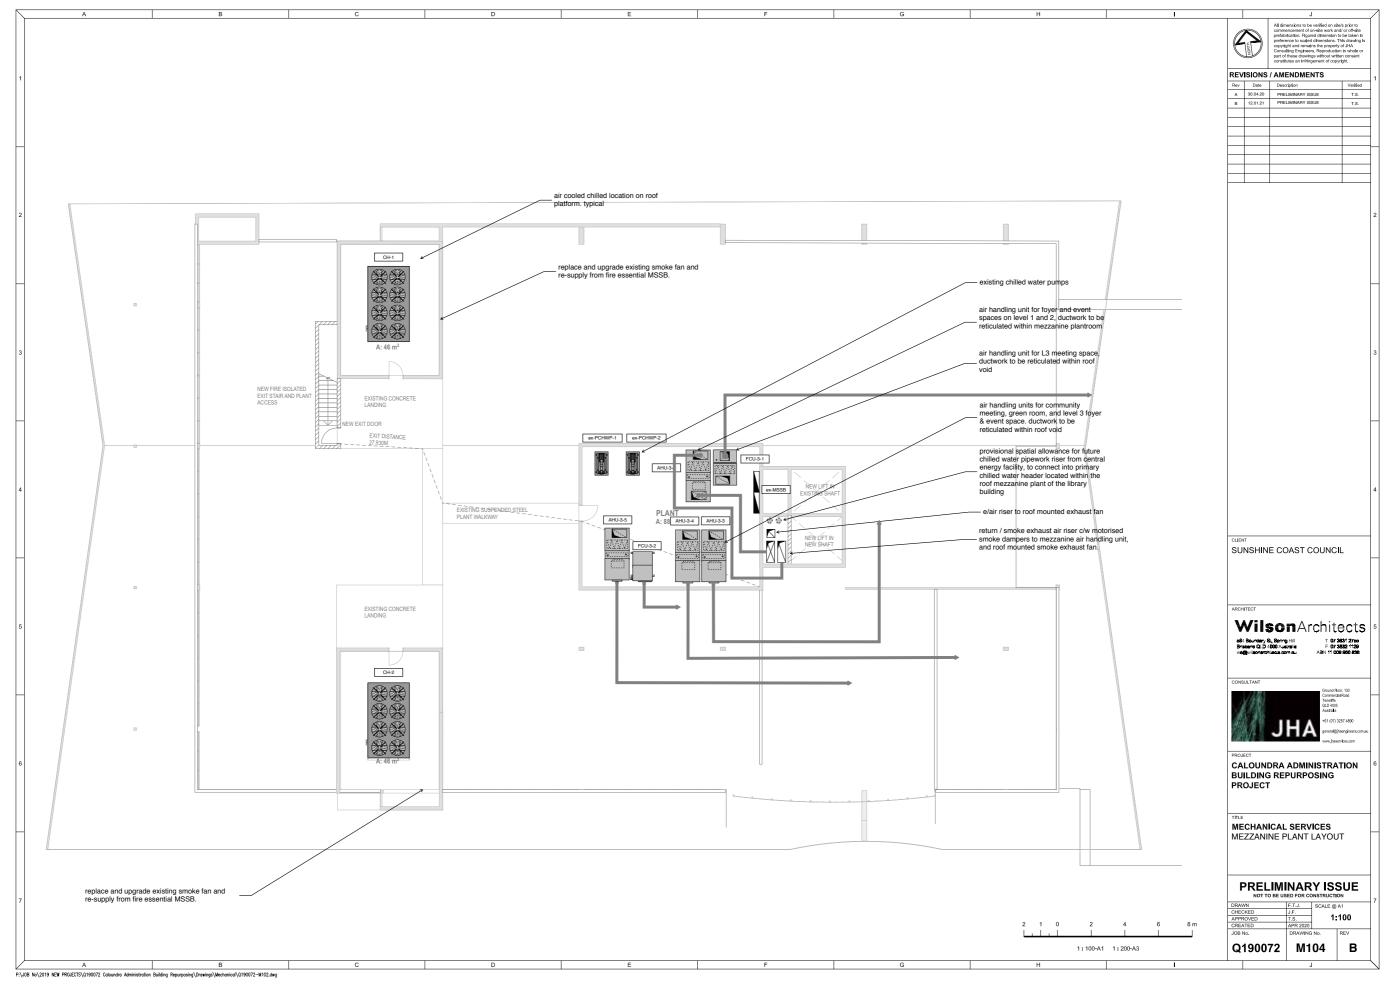



appendix 6 - sprinkler design drawings







CALOUNDRA ADMINISTRATION BUILDING **RE-PURPOSING PROJECT** 1 OMRAH AVENUE, CALOUNDRA QLD 4551 FIRE SPRINKLER SYSTEM

DRAWING SCHEDULE - FIRE PROTECTION SERVICES		
DRAWING NO.	DRAWING NAME	
8230101-F-0000-001	COVER SHEET, DRAWING SCHEDULE, LOCALITY PLAN, LEGEND, NOTES AND DESIGN CRITERIA	
8230101-F-0000-002	SCHEMATIC AND DETAILS	
8230101-F-0000-100	BASEMENT LEVEL	
8230101-F-0000-101	LEVEL 1	
8230101-F-0000-102	LEVEL 2	
8230101-F-0000-103	LEVEL 3	
8230101-F-0000-104	LEVEL 4	

	ABBREVIATIONS
JA	JACKING PUMP
RT	REMOTE TEST
N	NEW
E	EXISTING
D	DECOMMISSIONED AND REMOVED

LEGEND

LOLIND	
M	VALVE - ISOLATION (ABOVE GROUND)
м	VALVE - ISOLATION (BELOW GROUND)
N	VALVE - BUTTERFLY
Ы	VALVE - CHECK / NON-RETURN
×	VALVE - GLOBE (THROTTLING)
S	SPRINKLER CONTROL VALVE ASSEMBLY
	JACKING PUMP
Å	FLOW TEST ELEMENT
П	FLANGE
ନ	WATER MOTOR ALARM
	DUAL BOOSTER INLET
10-01	DUAL FEED OUTLET
	NEW PIPEWORK - MAIN (ABOVE GROUND)
	NEW PIPEWORK - MAIN (BELOW GROUND)
	EXISTING PIPEWORK - MAIN (ABOVE GROUND)
	EXISTING PIPEWORK - MAIN (BELOW GROUND)
M	VALVE MONITOR
PS	PRESSURE SWITCH
×	DRAIN - BY HYDRAULIC SERVICES
	WATER METER - BY HYDRAULIC SERVICES



LOCALITY PLAN SCALE: NTS

PROJECT LOCATION


COMPLIANCE:	COMPLY WITH NCC 20	19 A1 SPECIFICATION E1.5, AS 2118.1-20	117 AND THE PROJECT FIRE ENGINEERING REPORT	
PROTECTED ARE	A OCCUPANCY	CLASSIFICATION	REQUIREMENTS	
LEVEL 1, 2 AND 3	OFFICES AND LIBRARY	LIGHT HAZARD (STANDARD, CL. 9.2a)	LIGHT HAZARD - SIX (6) HYDRAULICALLY MOST UNFAVOURABLE Km8.0 SPRINKLERS, EACH OPERATING AT MINIMUM 70kPa	
BASEMENT	CARPARK	ORDINARY HAZARD 2	ORDINARY HAZARD 2 - TWELVE (12) HYDRAULICALLY MOST UNFAVOURABLE Km8.0 SPRINKLERS, EACH OPERATING AT MINIMUM 60 L/min	
LEVEL 4 (ROOF)	PLANT	ORDINARY HAZARD 1	ORDINARY HAZARD 1 - SIX (6) HYDRAULICALLY MOST UNFAVOURABLE Km8.0 SPRINKLERS, EACH OPERATING AT MINIMUM 60 L/min	
			FIRE SPRINKLER SYSTEM WATER SUPPLY	
COMPLIANCE:	SINGLE (AS 2118.1-201	7)		
REQUIREMENTS	TOWNS MAIN CONNEC TOWNS MAIN CONNEC REQUIRED TOWNS MAIN	TION SIZE: Ø100 NB	t 200 kPa, 28 L/sec at 200 kPa, and 27.5 L/sec at 275 kPa (all inclusive of allowance for two (2) fire hydrants supplied from the same town's main)	
NOTES:				
1. THESE DRA	WINGS TO BE READ IN CON.	JUNCTION WITH OMNII CONCEPT DESIG	N ADVICE 8230101 CA001.	
2. THESE DRA	WINGS TO BE READ IN CON.	JUNCTION WITH ARCHITECTURAL, STRU	ICTURAL AND ALL OTHER BUILDING SERVICES.	
THESE DRA	WINGS TO BE READ IN CON.	JUNCTION WITH INSURERS REQUIREMENT	NTS.	
THESE DRA	WINGS TO BE READ IN CON.	JUNCTION WITH THE CLIENT BRIEF.		
5. THESE DRA	WINGS TO BE READ IN CON.	JUNCTION WITH THE PROJECT FIRE ENG	SINEERING REPORT (FER).	
			HE NATIONAL CONSTRUCTION CODE (NCC 2019) DEEMED TO SATISFY (DTS) PROVISIONS AND INCORPORATE THE REQUIREMENTS OF ANY PERFORMANCE SOLU" S AND INCLUDE ANY ADDITIONAL REQUIREMENTS OVER AND ABOVE THE MINIMUM DTS REQUIREMENTS.	JTION REL
ALL AREAS	OF THE BUILDING SHALL BE	E FULLY PROTECTED WITH FIRE PROTEC	TION SERVICES IN ACCORDANCE WITH NCC 2019, PROJECT FIRE ENGINEERING REPORT (IF APPLICABLE), EVEN IF NOT SPECIFICALLY NOTED IN THE DOCUMENT	TATION.
8. EQUIPMENT	NOMINATED IS INDICATIVE	E ONLY, ALLOW TO PROVIDE CAPACITY A	AND PERFORMANCE AS REQUIRED TO SUIT THE SYSTEM REQUIREMENTS.	
9. ALL WORKS	ARE TO BE UNDERTAKEN B	Y A REGISTERED AND APPROPRIATELY	LICENSED CONTRACTOR.	
10. THE COMPL	ETE INSTALLATION SHALL	BE OF FIRST QUALITY WORKMANSHIP A	ND TO THE APPROVAL OF THE CLIENT OR CLIENT'S REPRESENTATIVE.	
		DMPLY WITH THE CODES, STANDARDS, F AL IS GRANTED, SHALL BE USED UNLESS	RULES AND REGULATIONS OF ALL STATUTORY AUTHORITIES HAVING JURISDICTION OVER THE WORKS. THE LATEST STANDARDS & CODES LEGISLATED AT THE T NOTED OTHERWISE.	TIME
12. ALL EQUIPM	IENT USED SHALL INCLUDE	ALL RELEVANT APROVALS SUCH AS NO	C, ACTIVFIRE, LOCAL FIRE BRIGADE AND ANY OTHER AUTHORITY HAVING JURISDICTION.	
13. COORDINAT	E INSTALLATION WITH OTH	HER TRADES AND SERVICES TO THE APP	ROVAL OF THE CLIENT OR CLIENT'S REPRESENTATIVE.	
		NNER AS TO CAUSE THE LEAST INCONV IVE MEASURES FOR THE SAFETY OF THE	ENIENCE. THE CONTRACTOR SHALL BE RESPONSIBLE FOR ANY DAMAGE OR ALLOWANCE AND FOR ANY CLAIMS THAT MAY ARISE THERE FROM, ANY DAMAGE SI PUBLIC, STAFF AND THE BUILDING.	SHALL BE
15. NO CHANG	S TO THE DESIGN CRITERIA	A IS TO OCCUR WITHOUT EXPLICIT WRIT	TEN APPROVAL FROM THE CLIENT OR CLIENT'S REPRESENTATIVE. IF THERE IS A CONFLICT WITH THIS SCOPE, RESOLVE WITH THE CLIENT AND CLIENT'S REPRES	SENTATI
16. ALL DIMEN	SIONS SHALL BE CHECKED	AND VERIFIED ON SITE PRIOR TO COMMI	ENCEMENT OF WORK.	
17. PIPE SIZING	SHOWN IS MINIMUM INTER	RNAL DIAMETER.		

Sunshine Coast.

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PRELIMINARY CONCEPT DESIGN	27.08.20	TJR
FINAL CONCEPT DESIGN	01.09.20	TJR
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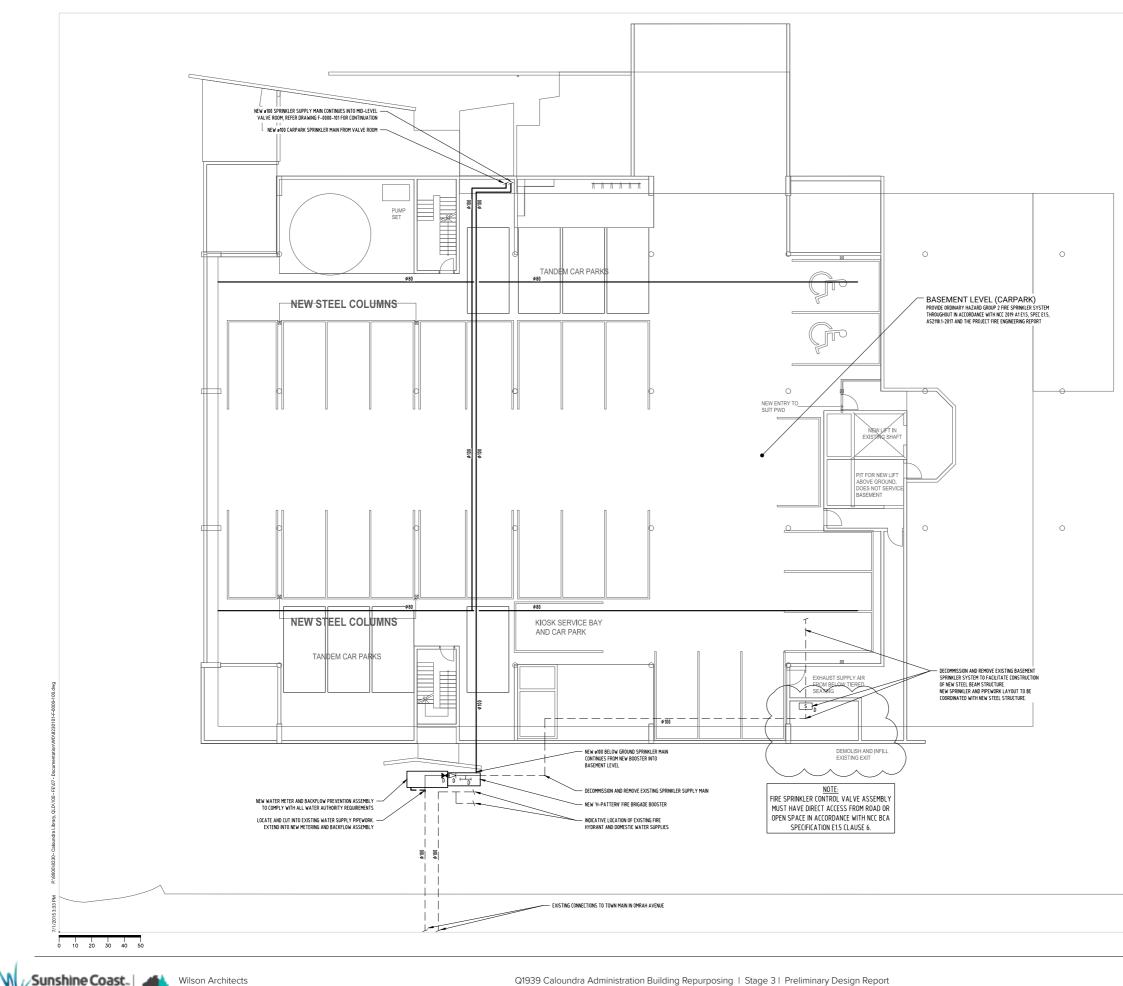




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Q1939 Caloundra Administration Building Repurposing | Stage 3 | Preliminary Design Report

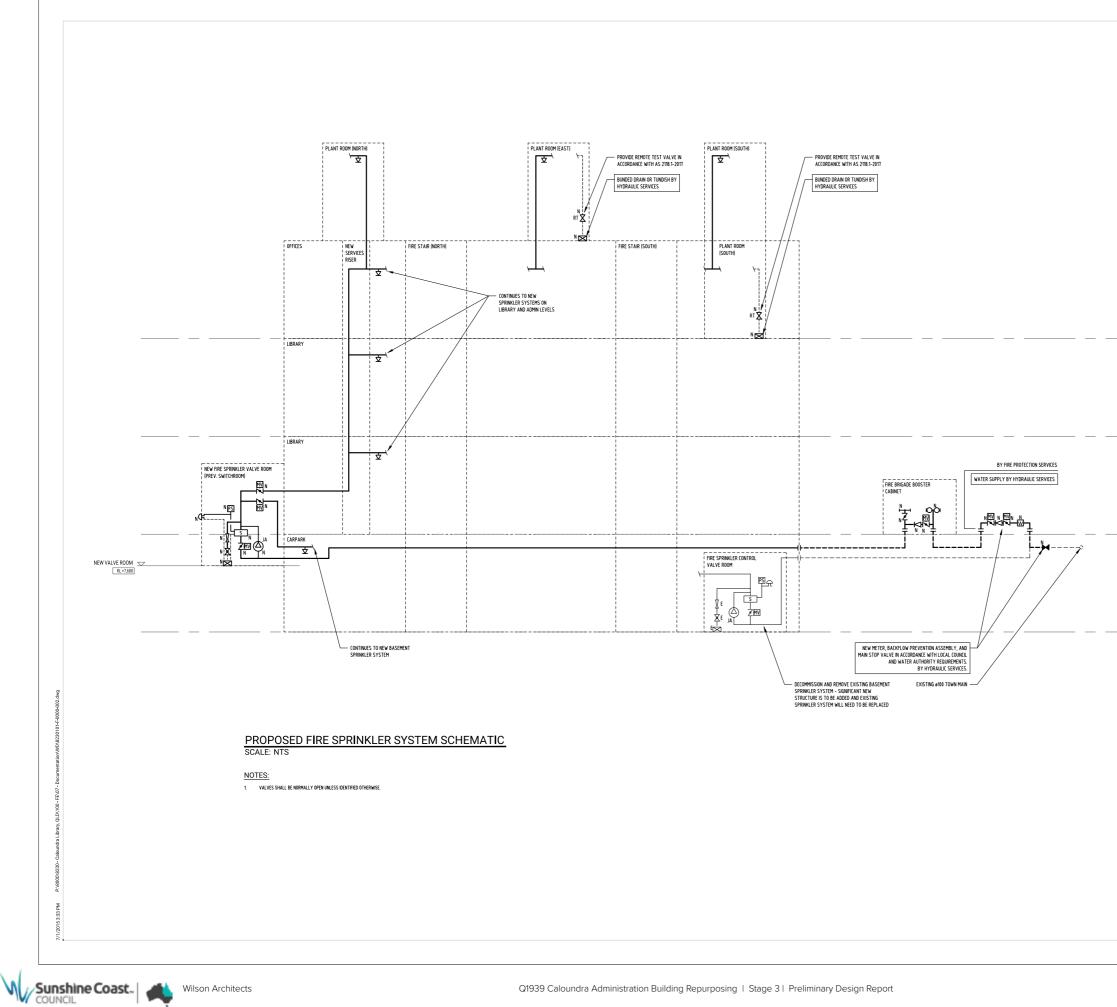
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	Consulting Fire Engine	ere
	T +61 7 3228 7878 W semilloomaas. A Ground Floor, 109 Coronation Drive, Milton Qid 406	4
	CALOUNDRA ADMIN BUILD	NG
	1 OMRAH AVE, CALOUNDRA QUEENSLAND 4551	
	DRAWING TITLE: FIRE PROTECTION SERVICES	
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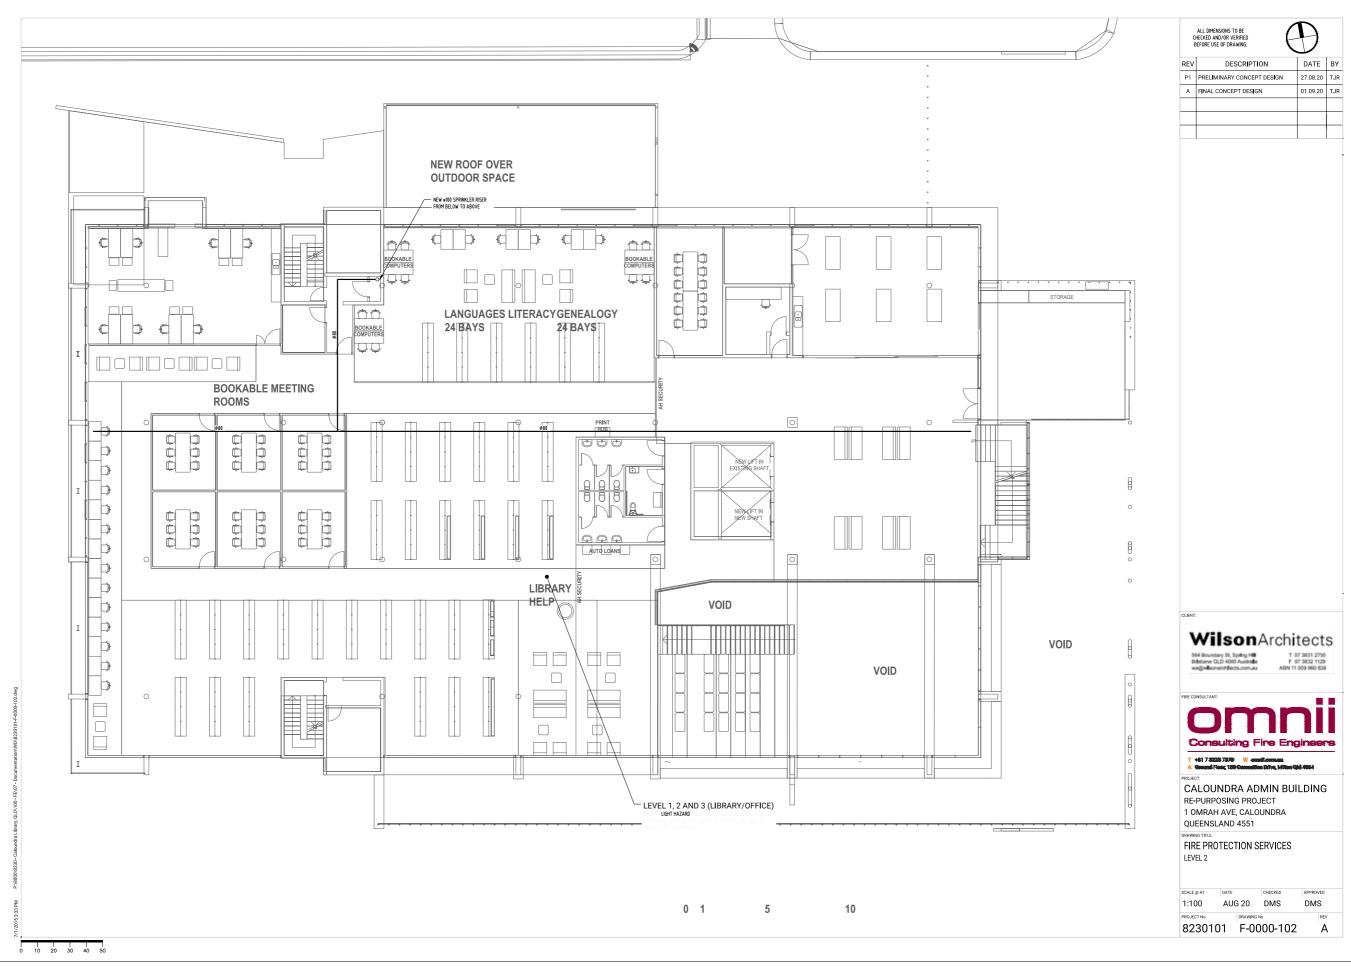
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P1	PRELIMINARY CONCEPT DESIGN	27.08.20	TJR
Α	FINAL CONCEPT DESIGN	01.09.20	TJR









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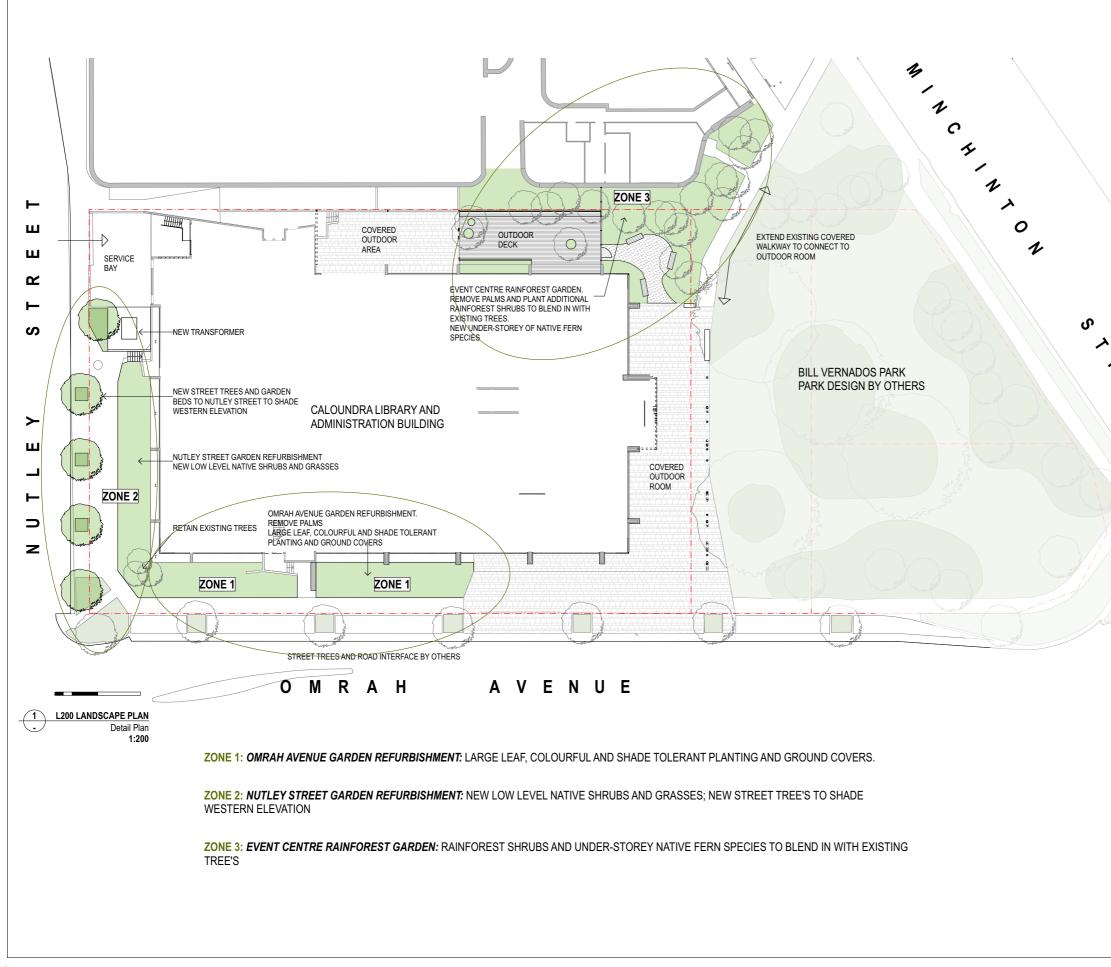

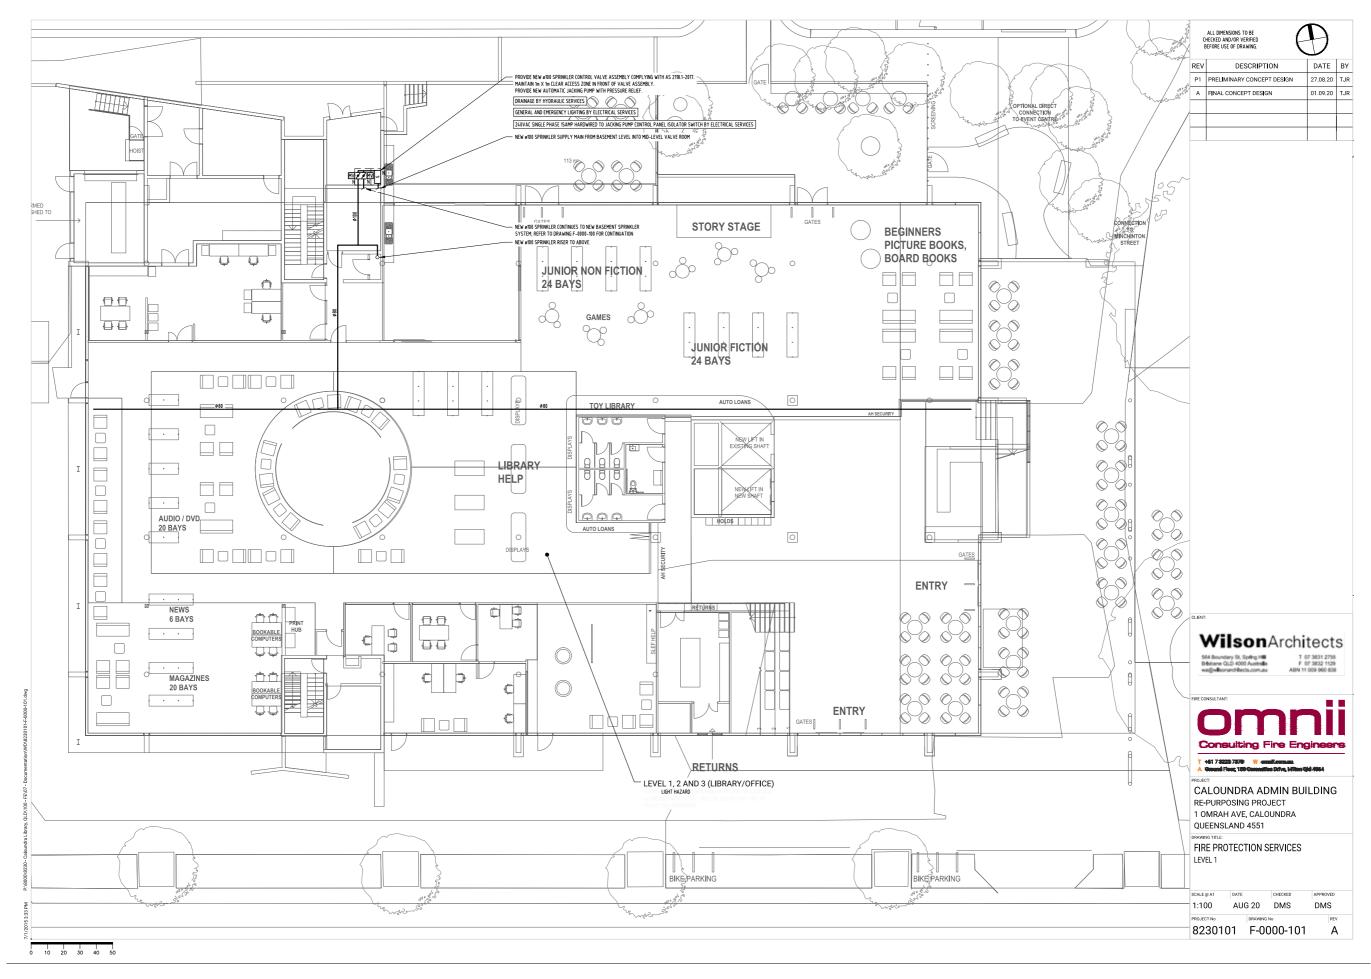
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Α	FINAL CONCEPT DESIGN	01.09.20	TJR

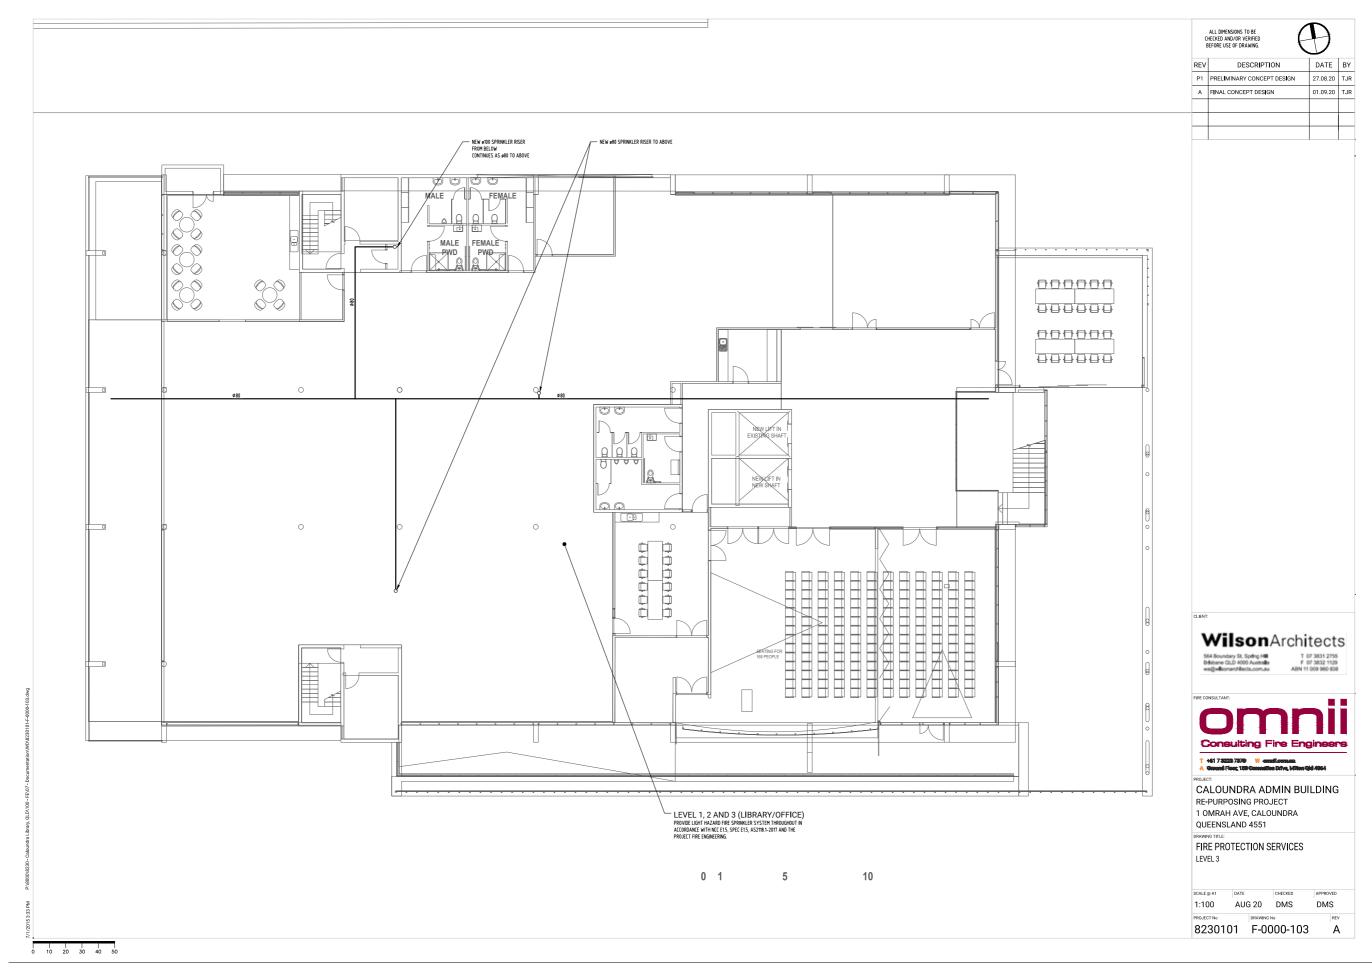

appendix 7 - landscape drawings

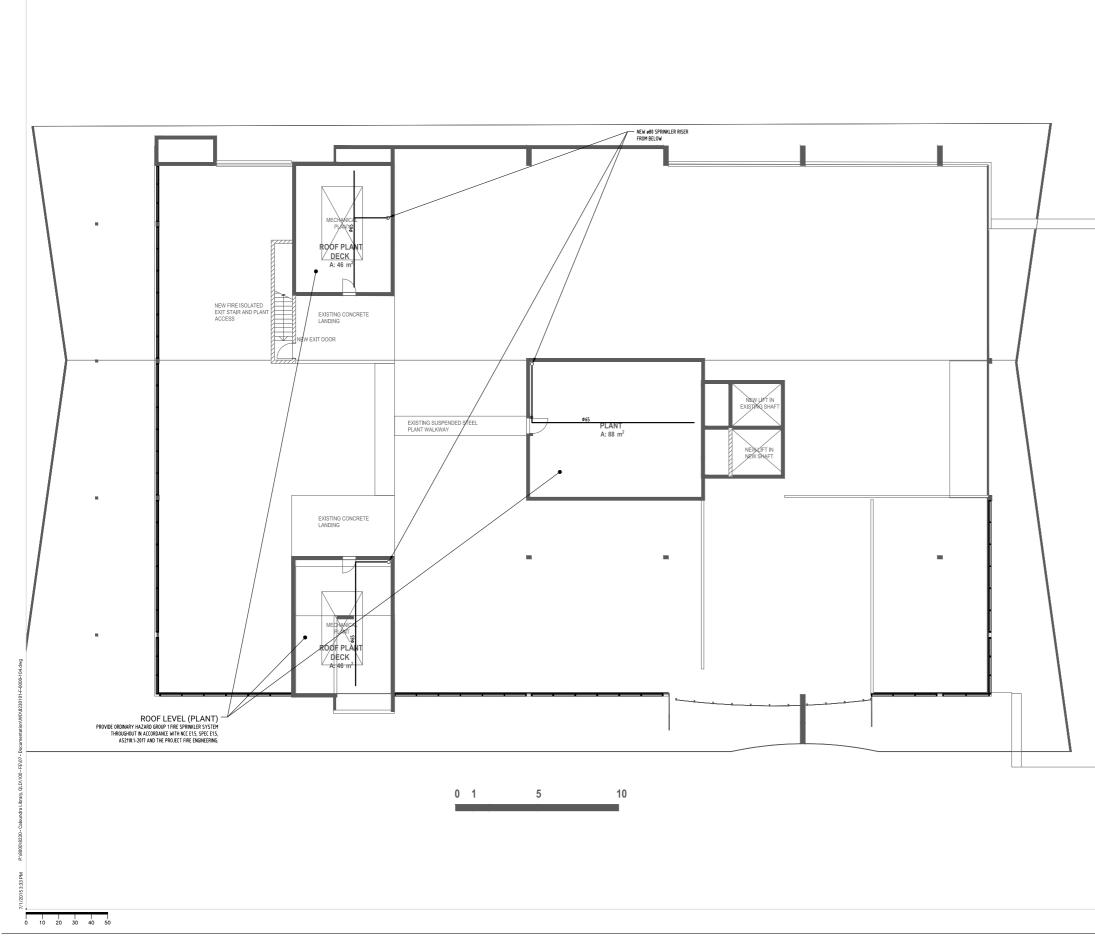



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	NOTEO
	NOTES
	1. Figured dimensions take precedence over scaled.
	Figured dimensions are millimetres unless noted otherwise.
	 Check all dimensions on site prior to commencement of work. These designs, drawings and specifications, and copyright thereof, are
	the property of Blair M Wilson and Associates Pty. Ltd. trading as Wilson Architects, and must not be used, retained or copied without the written
	authority of Wilson Architects.
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ZONE 1: OMRAH AVENUE GARDEN REFURBISHMENT: LARGE LEAF, COLOURFUL AND SHADE TOLERANT PLANTING AND GROUND COVERS.

PLANTING SCHEME BORROWS FROM THE BILL VERNADOS PARK PLANT PALETTE: Bromeliads, Birds Nest Ferns, Ixora's, and large leafed variegated plant species





Bromeliad species

Codiaeum variegatum species

Ixora species


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ZONE 2: NUTLEY STREET GARDEN REFURBISHMENT: NEW LOW LEVEL NATIVE SHRUBS AND GRASSES; NEW STREET TREE'S TO SHADE WESTERN ELEVATION STREET TREE OPTIONS LOW LEVEL RESILIENT NATIVE SHURBS, GRASSES AND ACCENT PLANTS



Cupaniopsis anacardiodes - to match species Brachychiton discolor over the other side of Nutley Street





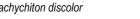

Hardenbergia violacea

Pimelea linifolia

Pultenaea villosa



ZONE 3: EVENT CENTRE RAINFOREST GARDEN: RAINFOREST SHRUBS AND UNDER-STOREY NATIVE FERN SPECIES TO BLEND IN WITH EXISTING TREE'S





Calochlaena dubia


Blechnum cartilagineum

Melastoma malabathricum

Asplenium australasicum

Dendrobium speciosum



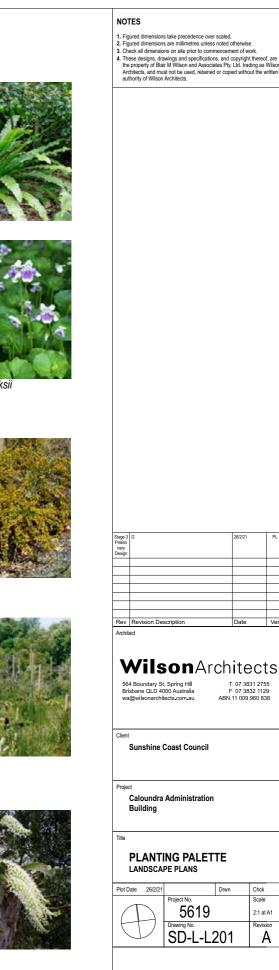

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